OGDEN PATTERSON LIQUOR STORE # 24

DEPARTMENT OF ALCOHOLIC BEVERAGE CONTROL D.F.C.M. PROJECT NO. 04180030

CONSTRUCTION DOCUMENTS
JANUARY 24, 2006

DESIGN TEAM

ARCHITECT:

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Salt Lake City UT, 84101 Phone: (801) 359-3158

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MECHANICAL ENGINEER:

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ELECTRICAL ENGINEER:

PYE, INC. 90 SOUTH 400 WEST # 340 SALT LAKE CITY, UTAH 84101 TELEPHONE: (801) 359-3158 FACSIMILE: (801) 521-4114


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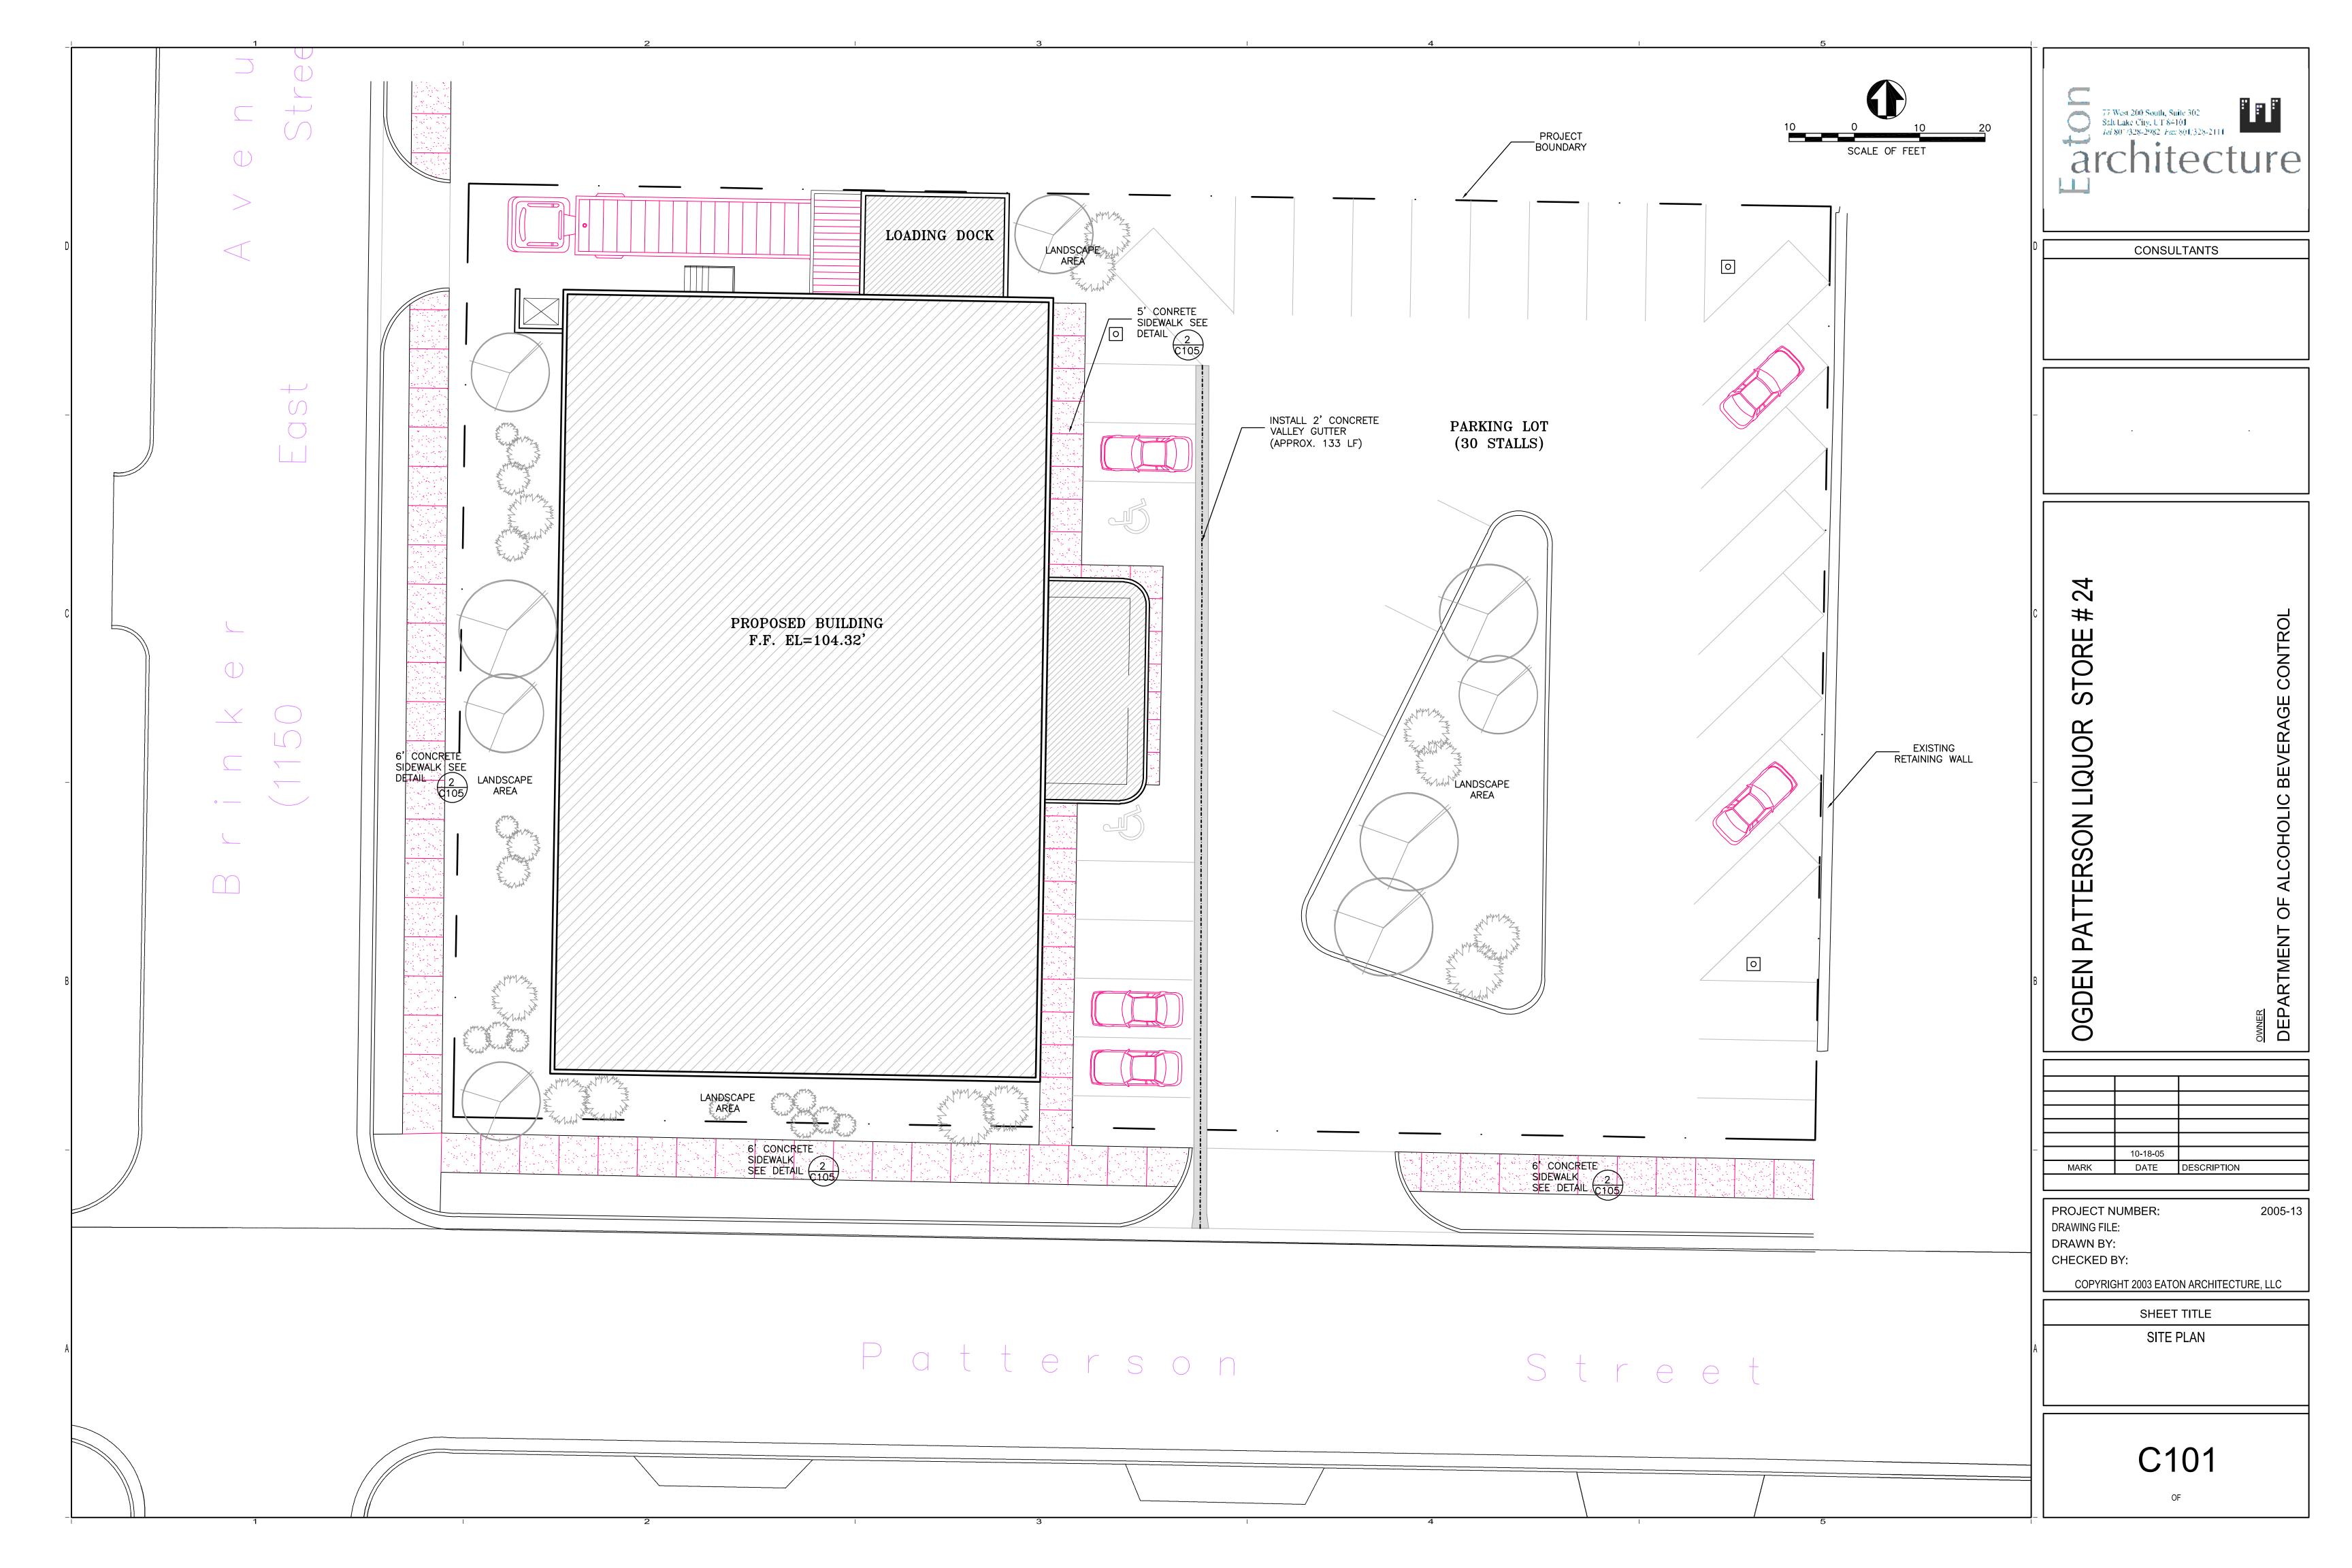
CONSTRUCTION CONTROL CORPORATION
460 SOUTH 400 EAST
SALT LAKE CITY, UTAH 84111
TELEPHONE: (801) 578-1201
FACSIMILE: (801) 578-2068


LIST OF DRAWINGS:


LANDSCAPING PLANTING AND IRRIGATION PLANS LANDSCAPE DETAILS **ARCHITECTURAL** ADIØI DEMOLITION PLAN ASIØI SITE PLAN FLOOR PLAN REFLECTED CEILING PLAN ENLARGED PLANS & INTERIOR ELEVATIONS A104 ENLARGED STAIR/RAMP PLANS EXTERIOR ELEVATIONS EXTERIOR ELEVATIONS BUILDING SECTIONS WALL SECTIONS DOOR & FRAME SCHEDULE WINDOW TYPES AND DETAILS DETAILS A602 DETAILS STRUCTURAL GENERAL STRUCTURAL NOTES & DETAILS DETAILS FOUNDATION PLAN ROOF FRAMING PLAN S3Ø1 MECHANICAL MECHANICAL SCHEDULES MECHANICAL ROOF PLAN MECHANICAL FLOOR PLAN MECHANICAL DETAILS M602 MECHANICAL DETAILS PLUMBING P201 PLUMBING FLOOR PLAN **ELECTRICAL** ELECTRICAL NOTES, SYMBOLS AND SCHEDULES ELECTRICAL SITE PLAN E1Ø1 LIGHTING FLOOR PLAN POWER FLOOR PLAN SCHEDULES & SCHEMATICS


CODE ANALYSIS




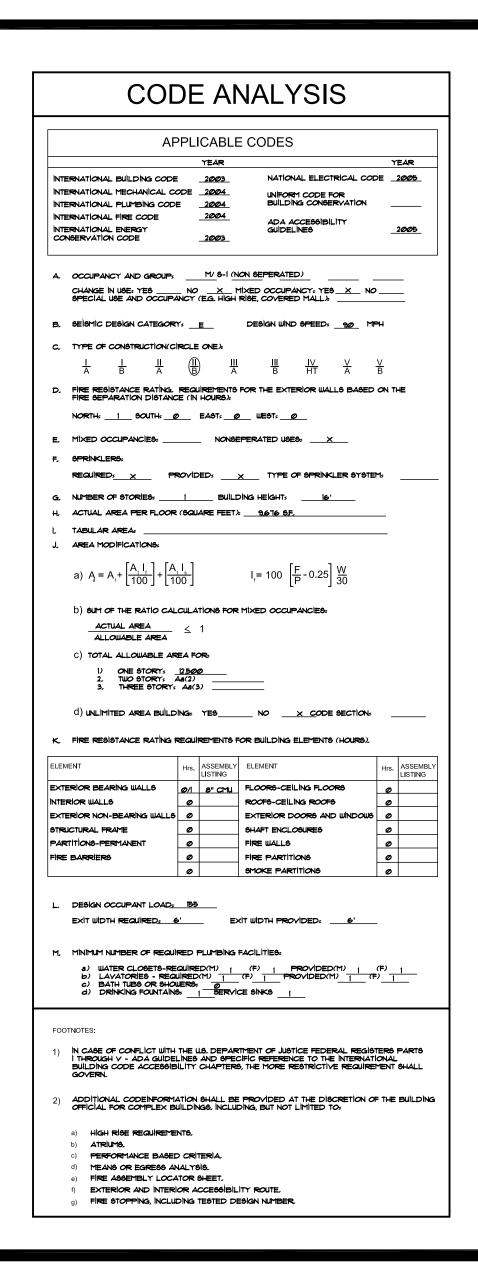

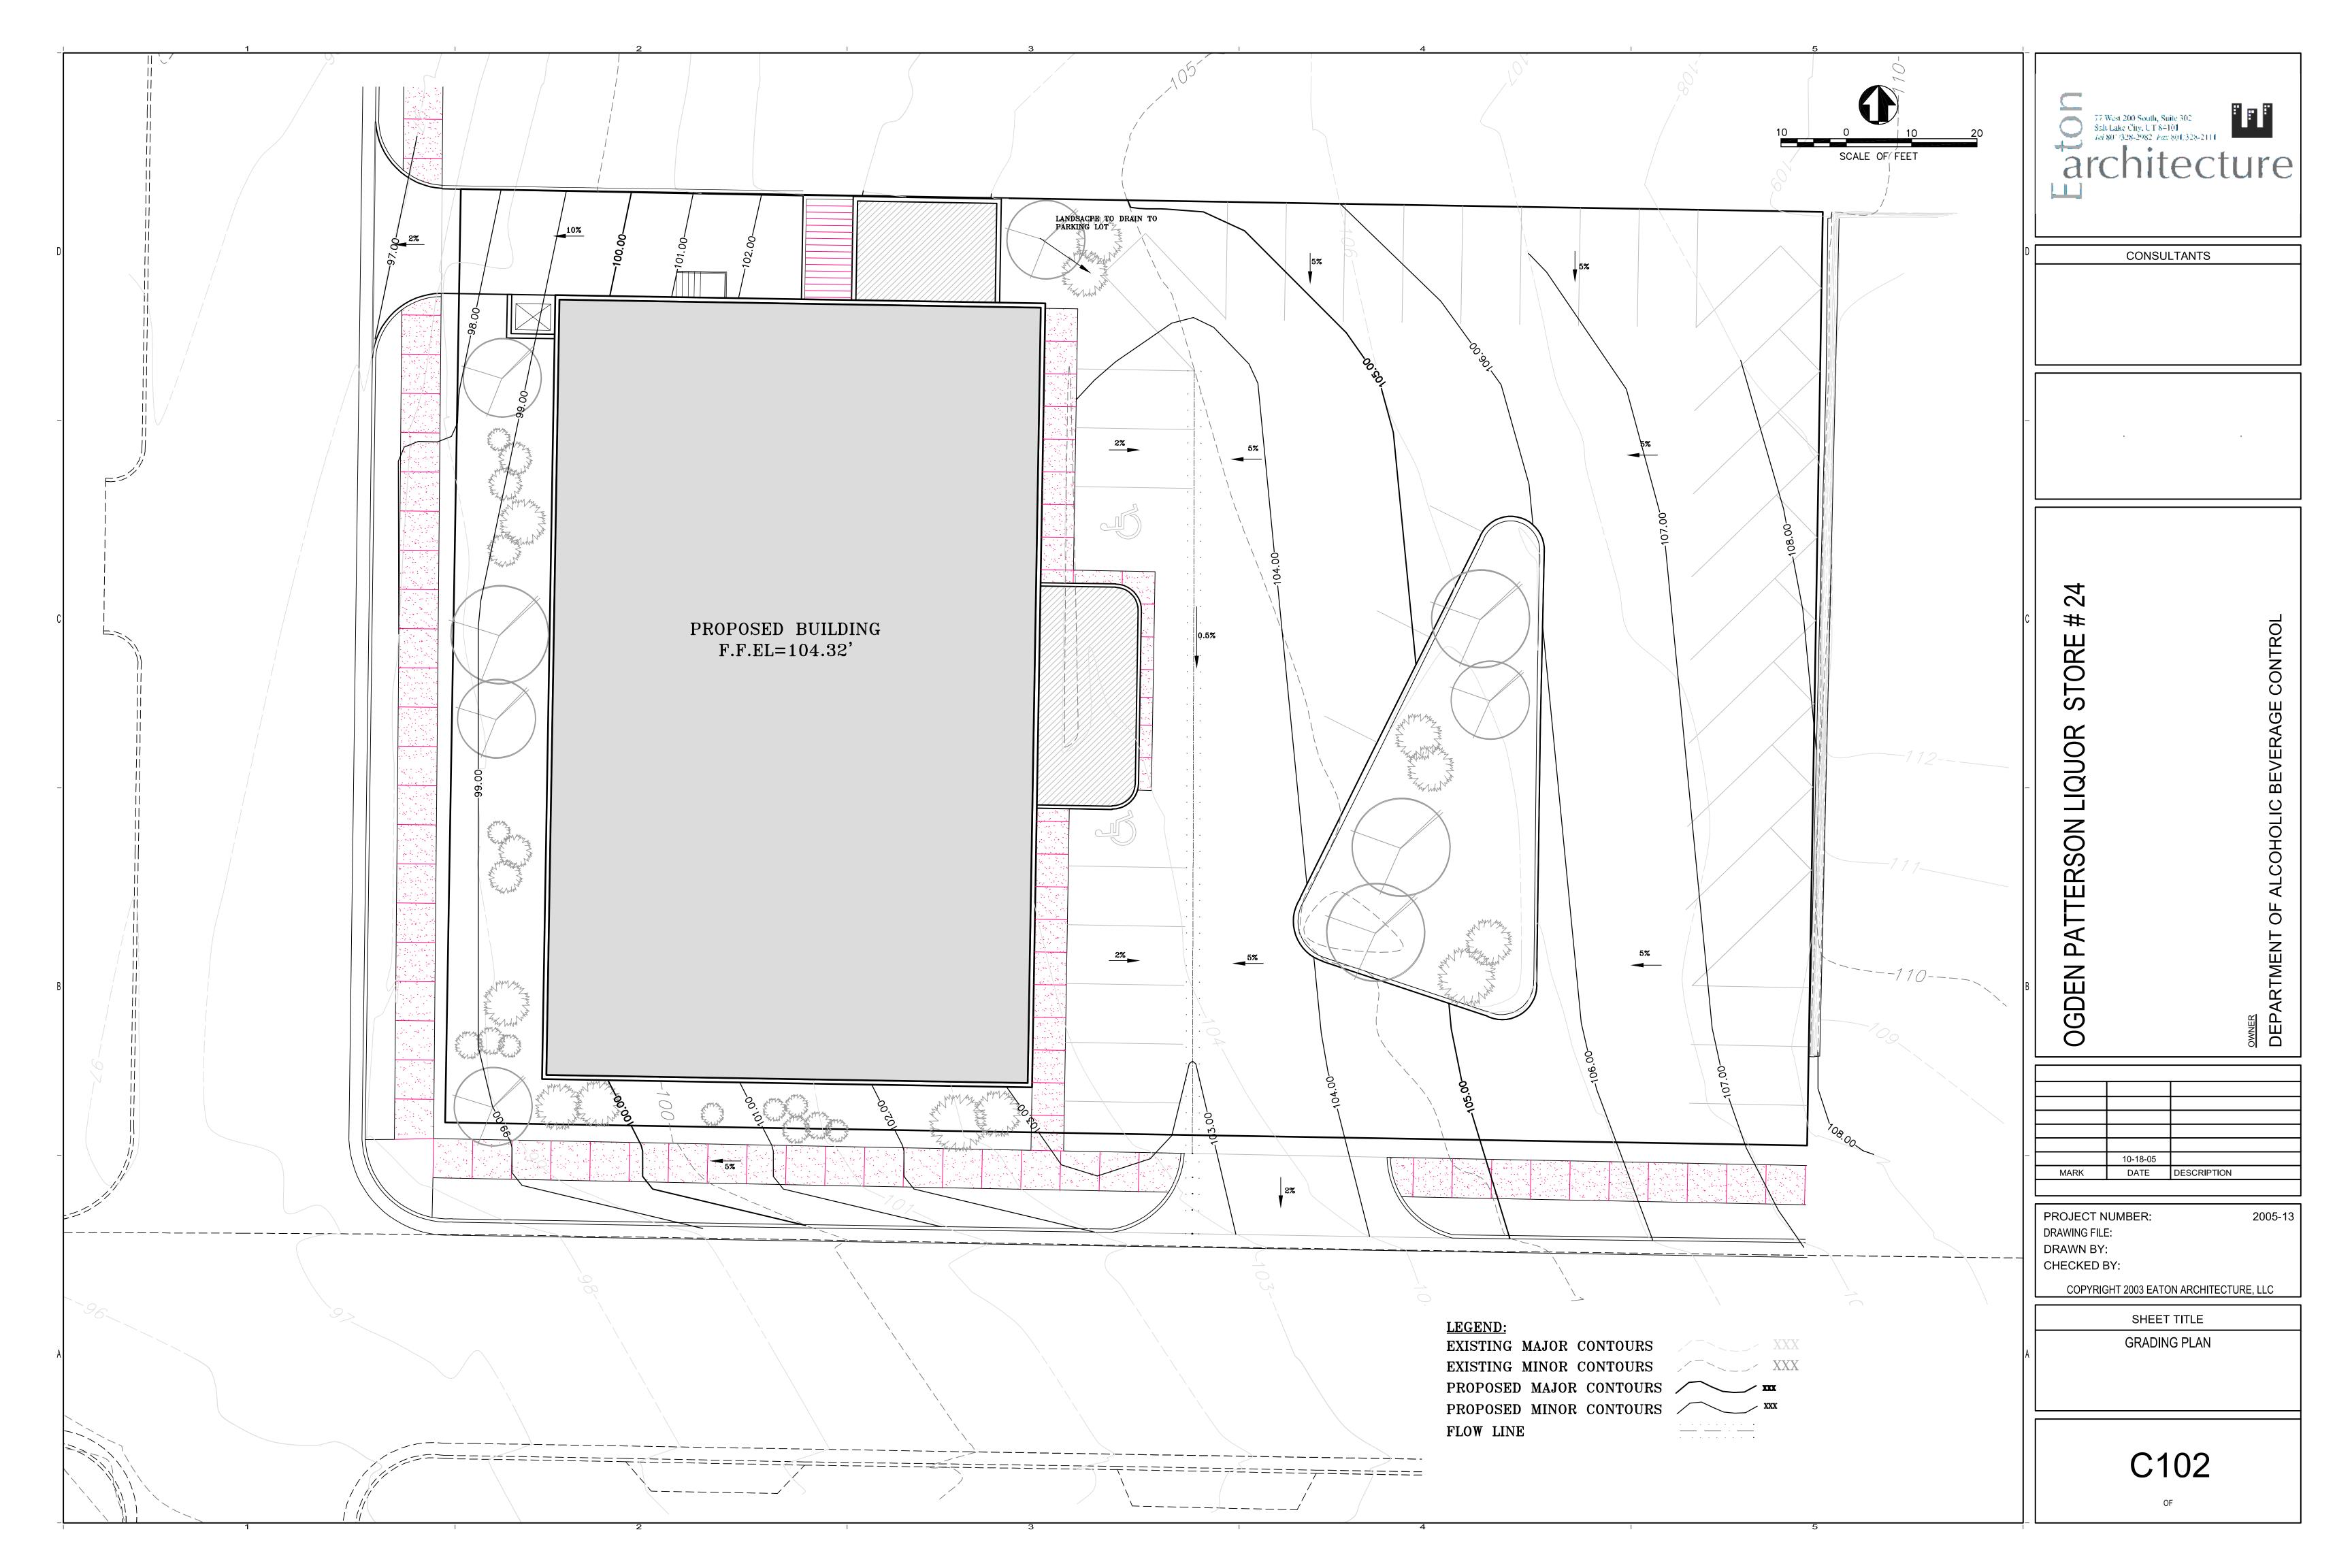

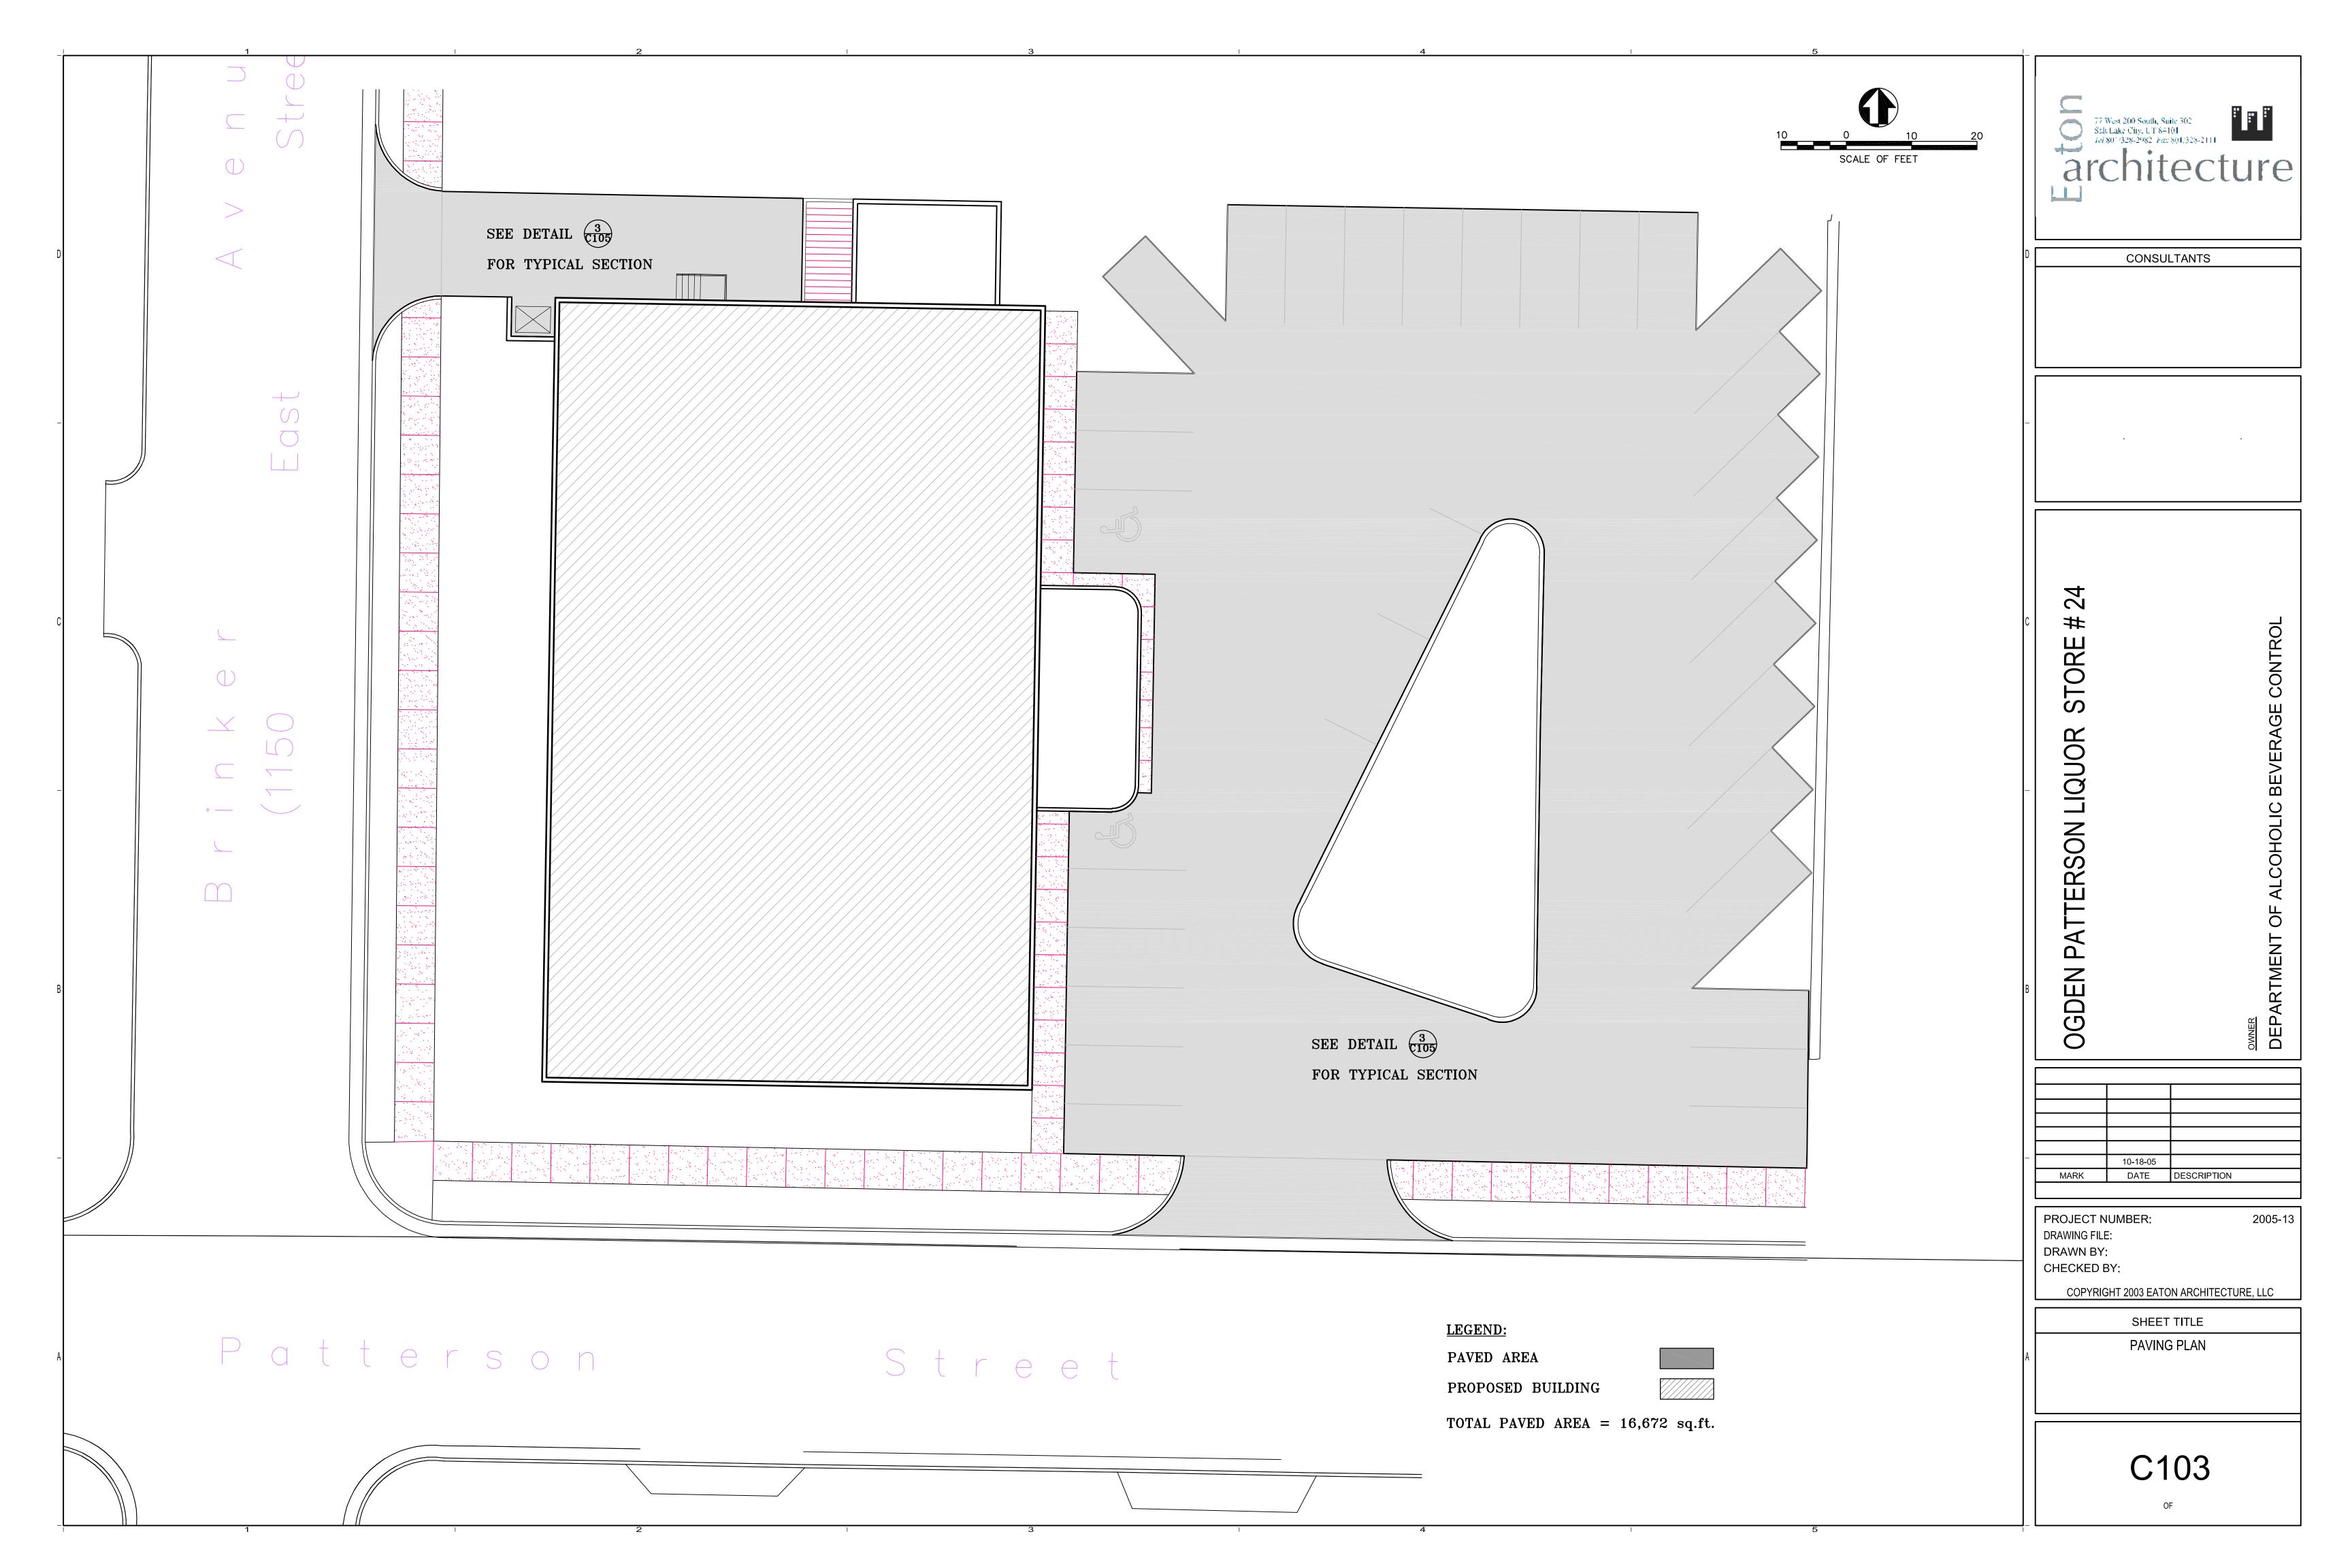

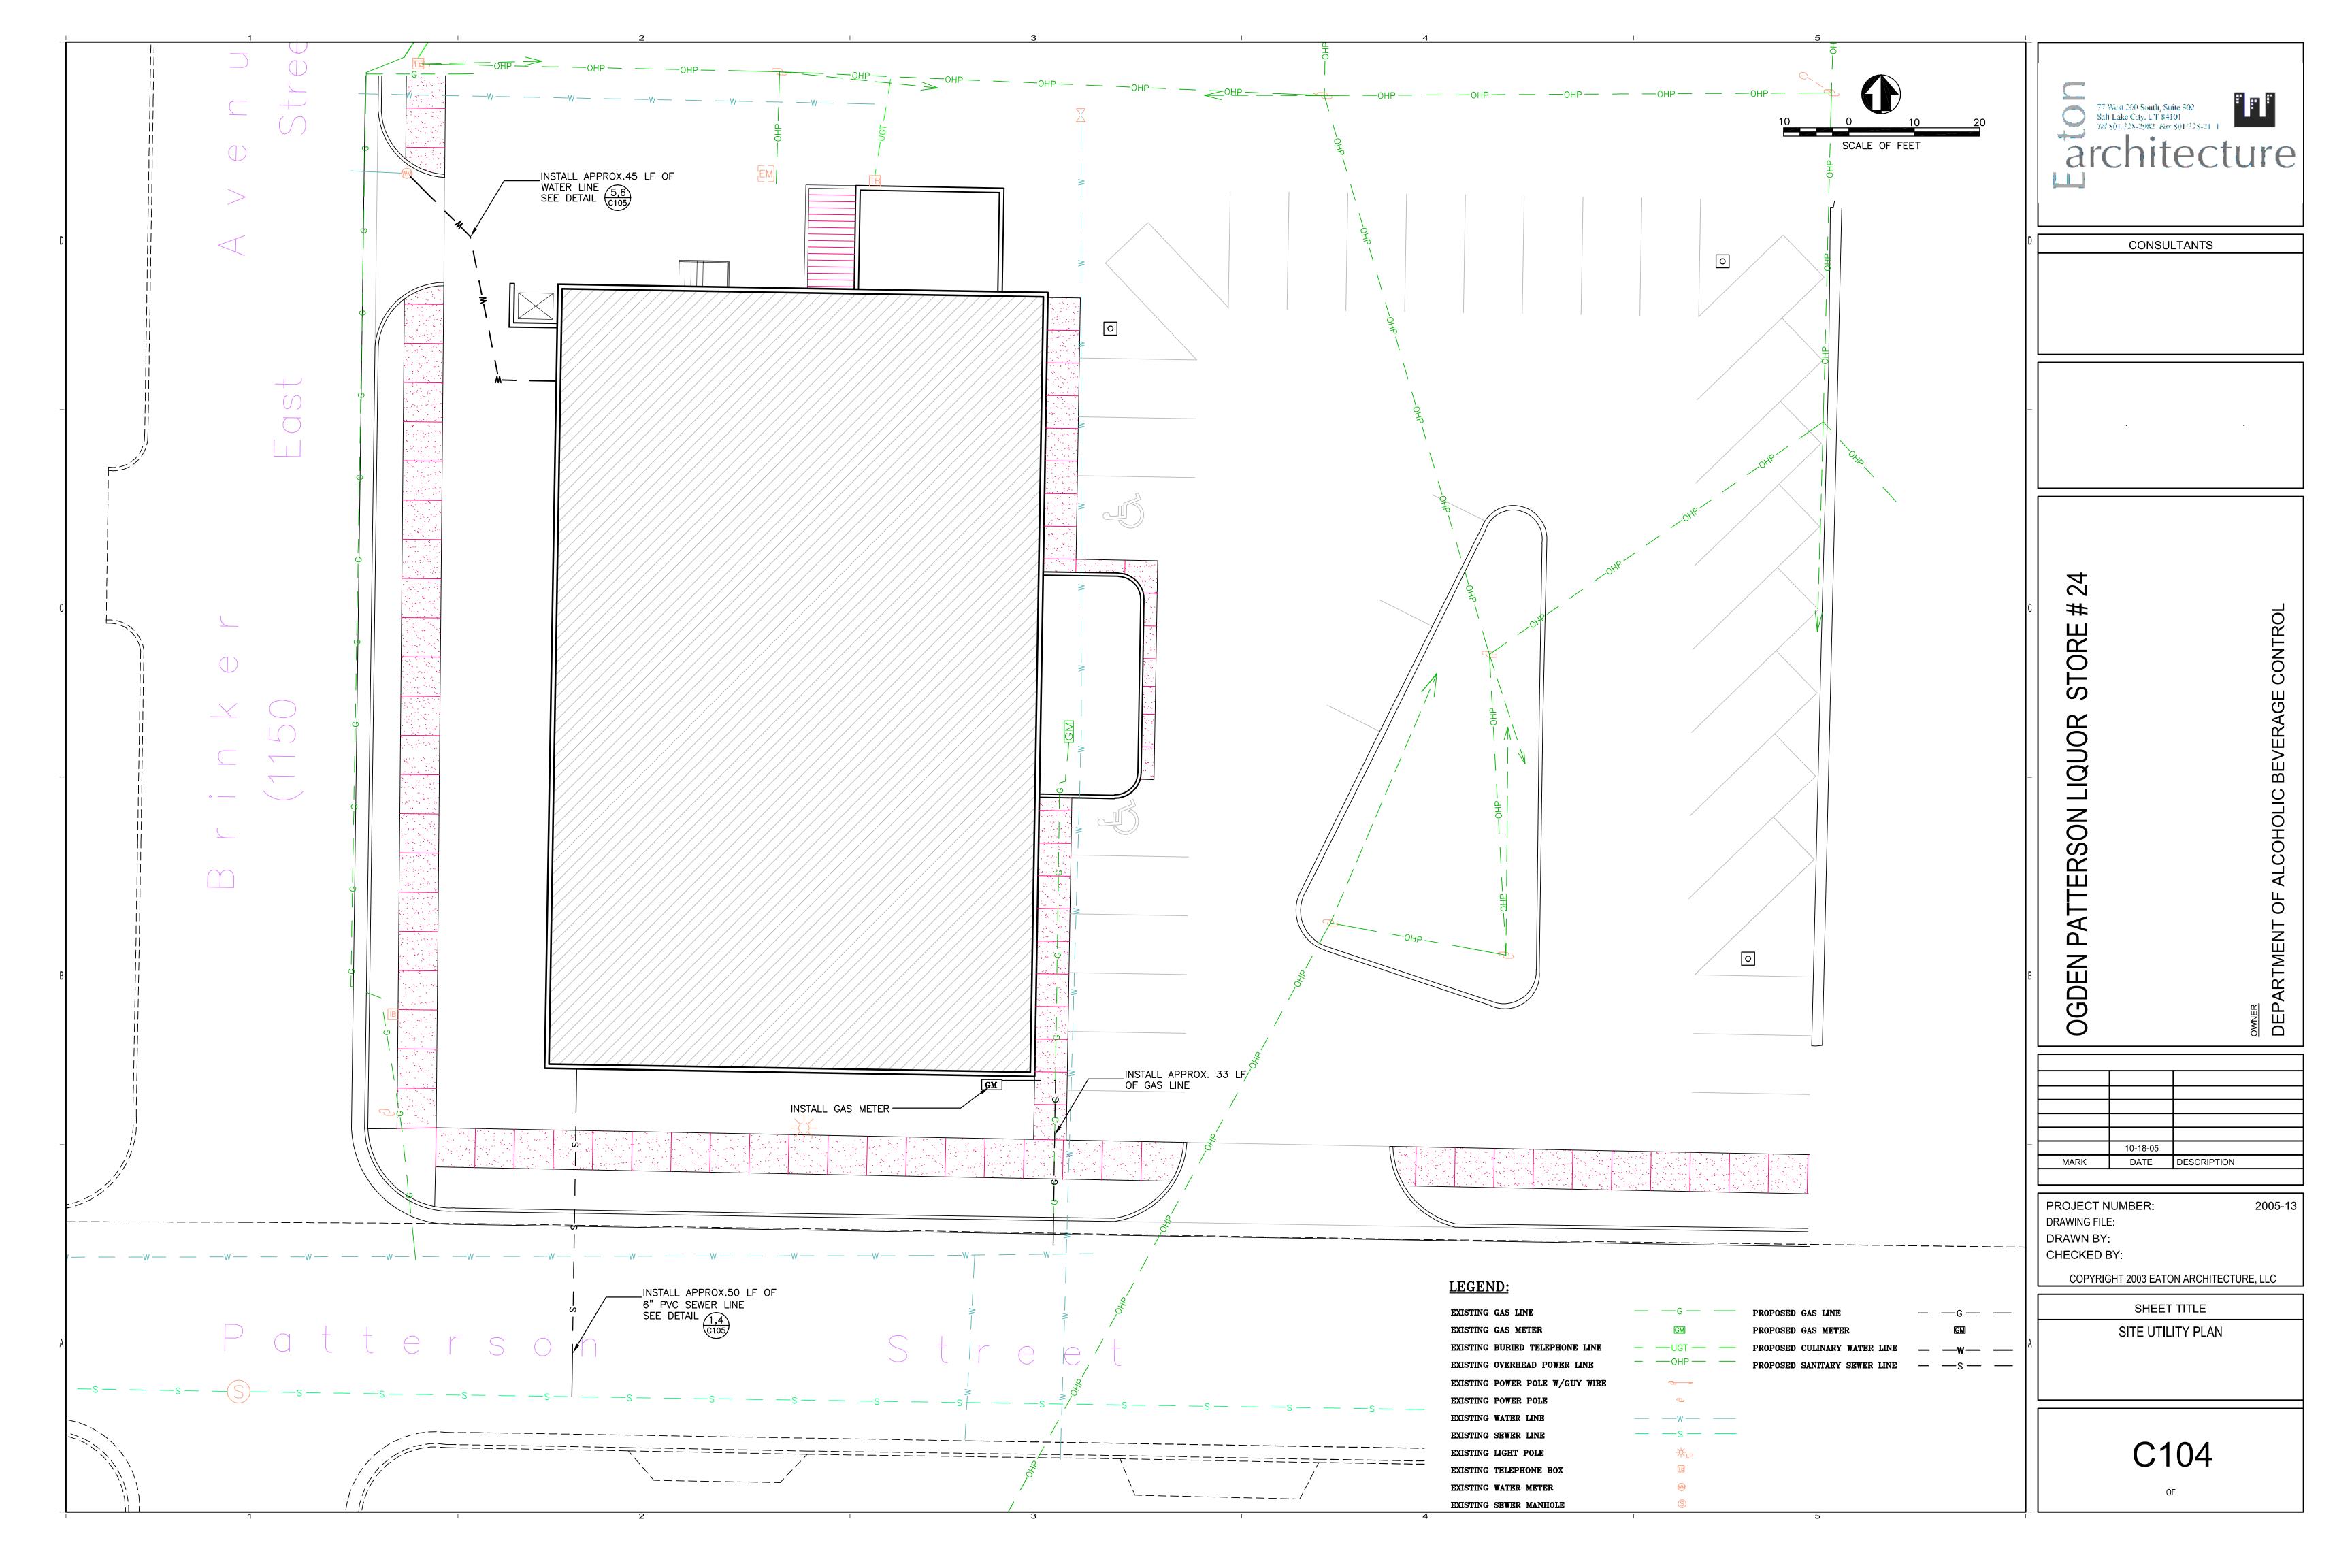

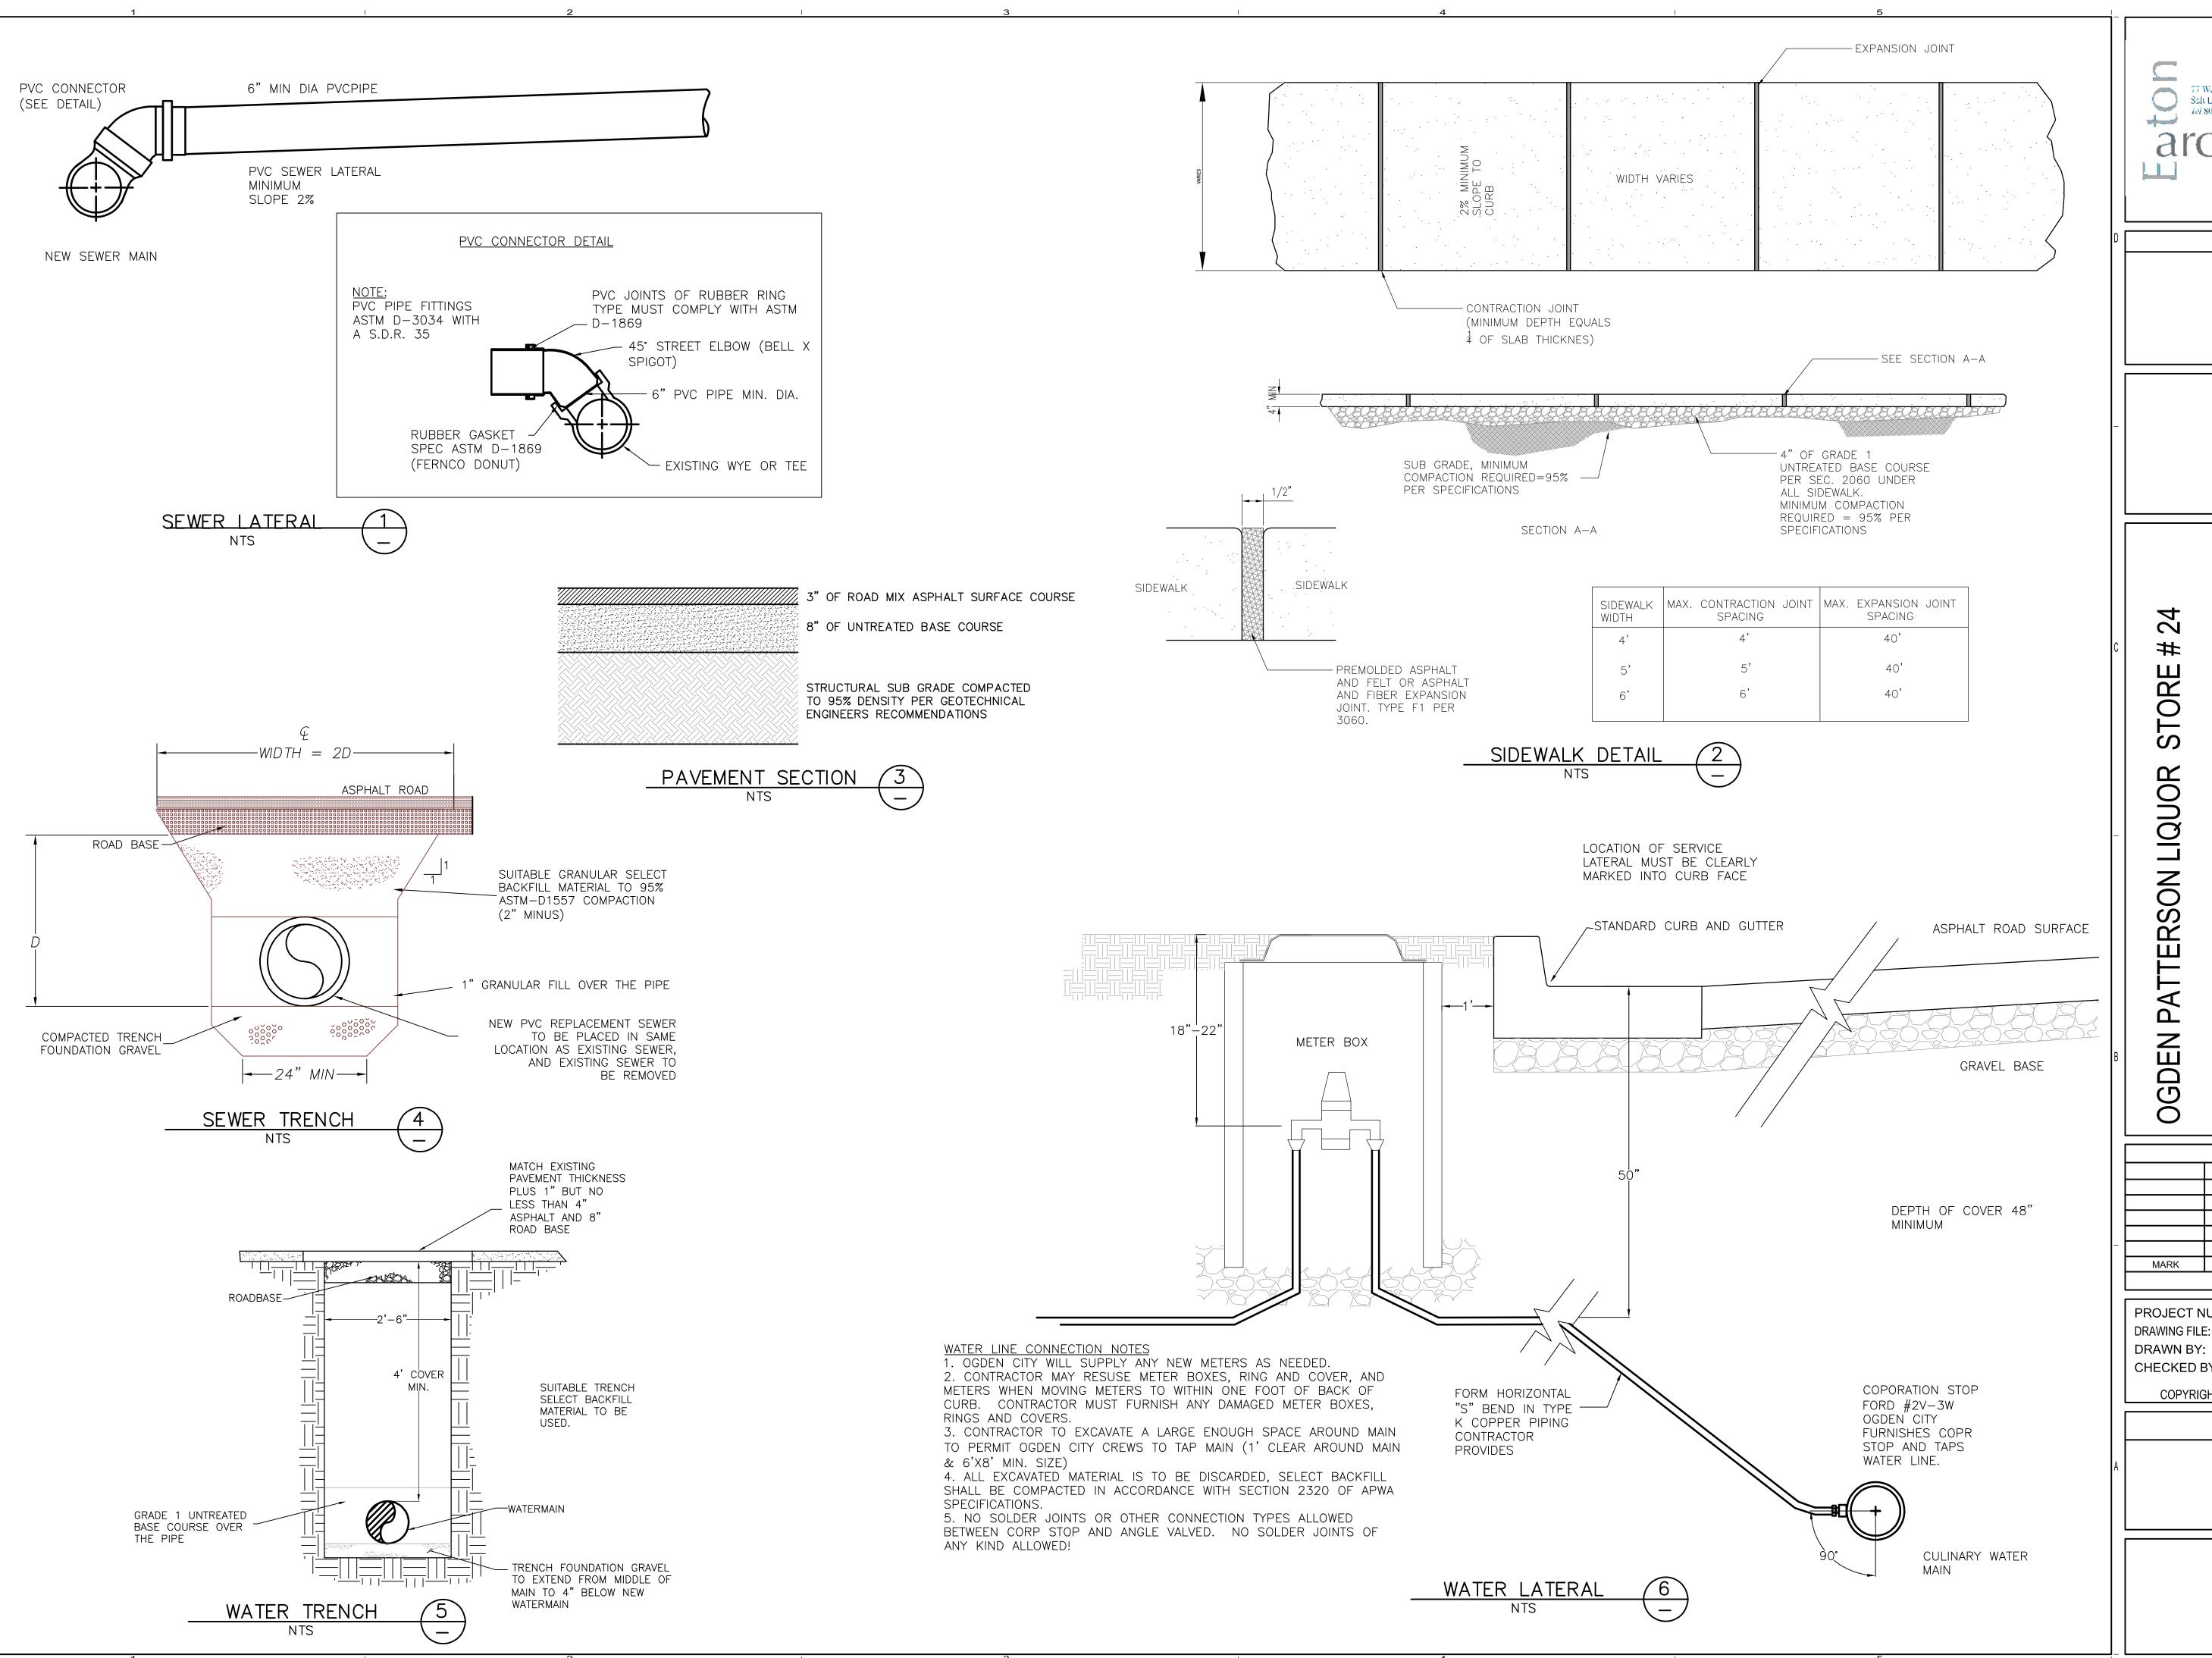



CONSULTANTS

OWNER

DEPARTMENT OF ALCOHOLIC BEVERAGE CONTROL

10-18-05
MARK DATE DESCRIPTION

PROJECT NUMBER: 2005-13
DRAWING FILE:
DRAWN BY:
CHECKED BY:
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SHEET TITLE
DETAILS SHEET

C105

OF

IRRIGATION LEGEND

SYM DESCRIPTION

RAINBIRD 1804-PRS-12Q

ARAINBIRD 1804-PRS-12H

RAINBIRD 1804-PRS-15EST

RAINBIRD 1804-PRS-15SST

RAINBIRD 1804-PRS-15Q

RAINBIRD 1804-PRS-15F

RAINBIRD 1804-PRS-15H

RAINBIRD 1804-PRS-15TQ

RAINBIRD 1812-PRS-12H

RAINBIRD 1812-PRS-12Q

RAINBIRD 100-PESB SERIES ELEC. REMOTE CONTROL VALVE (1")

LATERAL LINE - PVC SCH 40. S.A.S 12" BURY. • 1"

--- MAINLINE - 2" SCH 40 PVC - SIZED AS SHOWN

ONE 14 GAGE U.F. DIRECT BURIAL WHITE GROUND WIRE. ONE 14 GAGE U.F. DIRECT BURIAL BLUE GROUND WIRE (SPAR²). ONE 8 WIRE STRAND (18 GAGE) CONTROL WIRE. CONNECT TO CONTROLLER AS INDICATED ON THE DRAWINGS.

CONTROLLER--RAINBIRD ESP-12LX

SLEEVES - 4" PVC SCH 40 PIPE. GLUE JOINTS AS REQUIRED.

BACK FLOW PREVENTER - WILKINS 975XL - REDUCED PRESSURE PRINCIPLE . SAME SIZE AS MAINLINE

NOTES:


POINT OF CONNECTION.


BURY 4" DIA PVC SCH 40 SLEEVE @ 12" DEPTH TO FLOW LINE.

THIS SPRINKLER IRRIGATION PLAN IS DRAWN FOR GRAPHIC CLARITY. WHERE PIPING AND VALVES ARE SHOWN IN CONCRETE AREAS, EXCEPT WHERE CROSSING, THE INTENT IS FOR THE PIPING AND VALVES TO BE PLACED IN THE ADJACENT PLANTING AREAS.

PLANT SCHEDULE

SYM	BOTANICAL	COMMON	SIZE COND
	TREES		
Α	Acer p. schwedlerii	Schwedler Maple	2" C. B&B
В	Gled.t. Shade.	Shademaster Hon.	2" C. B&B
С	Acer p. columnare	Columnar Maple	2"C. B&B
	SHRUBS		
D	Cornus s. 'kelseyi'	Dwarf Dogwood	5 G. Can
Ε	Cotoneaster apic.	Cranberry Cot.	5 G. Can
F	Enonymus a. com.	Burning Bush	5 G. Can
G	Hemerocallis	Daylily (r & y)	1 G. Can
Н	Mis. s. zebrina	Zebra Grass	1 G. Can
I	Pinus m. m. pum.	Dwf. Mugho Pine	5 G. Can
	GROUND C	COVER	
J	Hypericum reptans	St. John's Wart	4" Pot

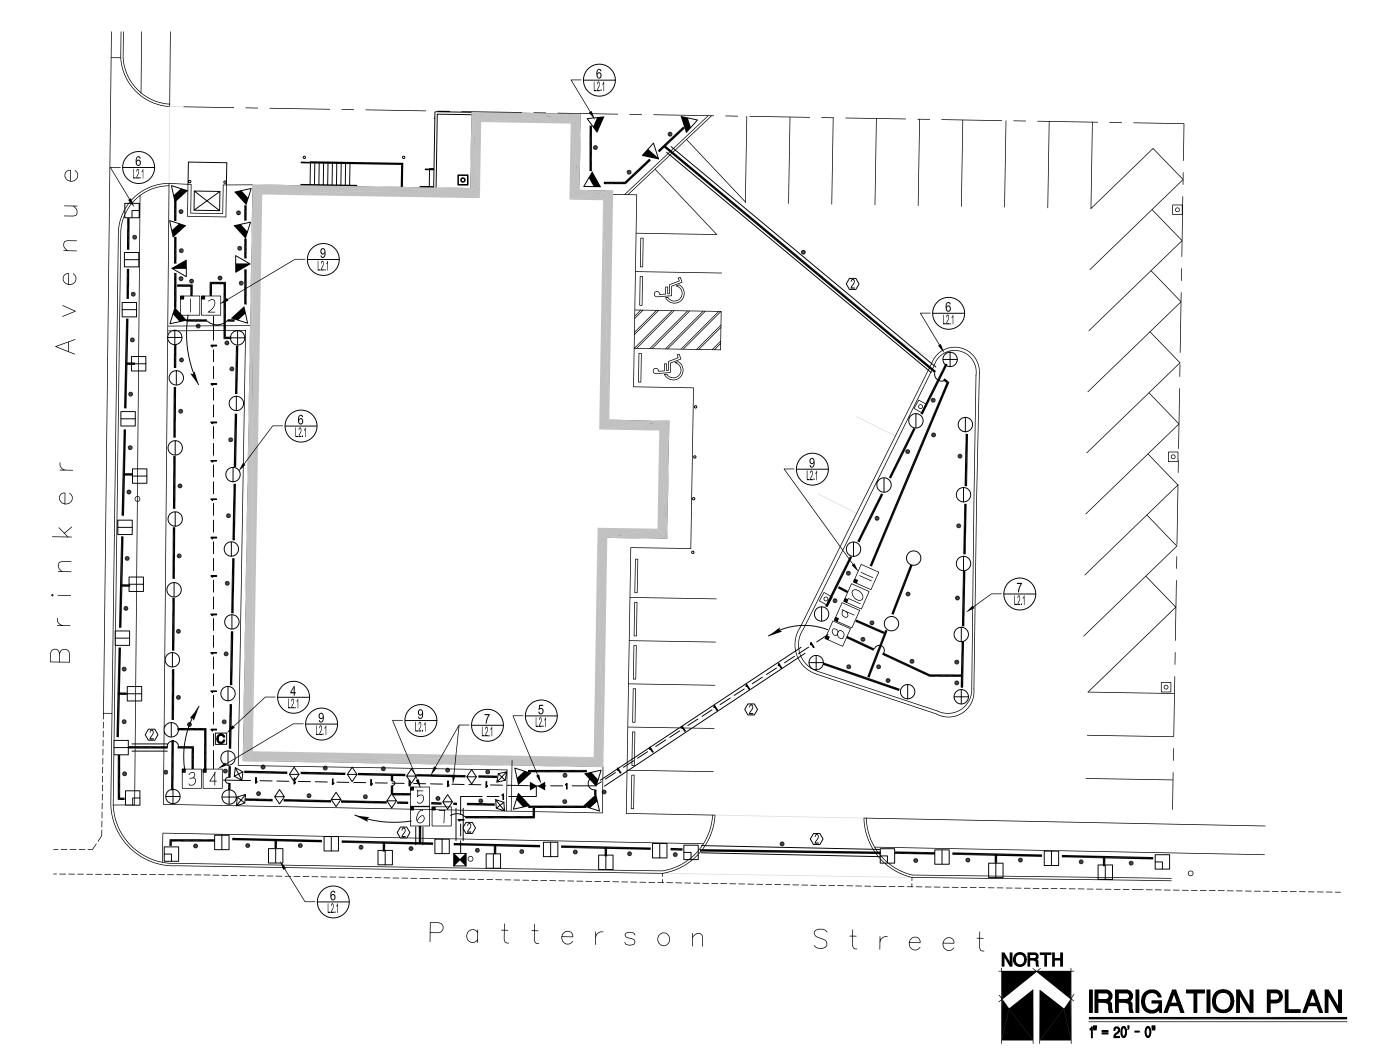

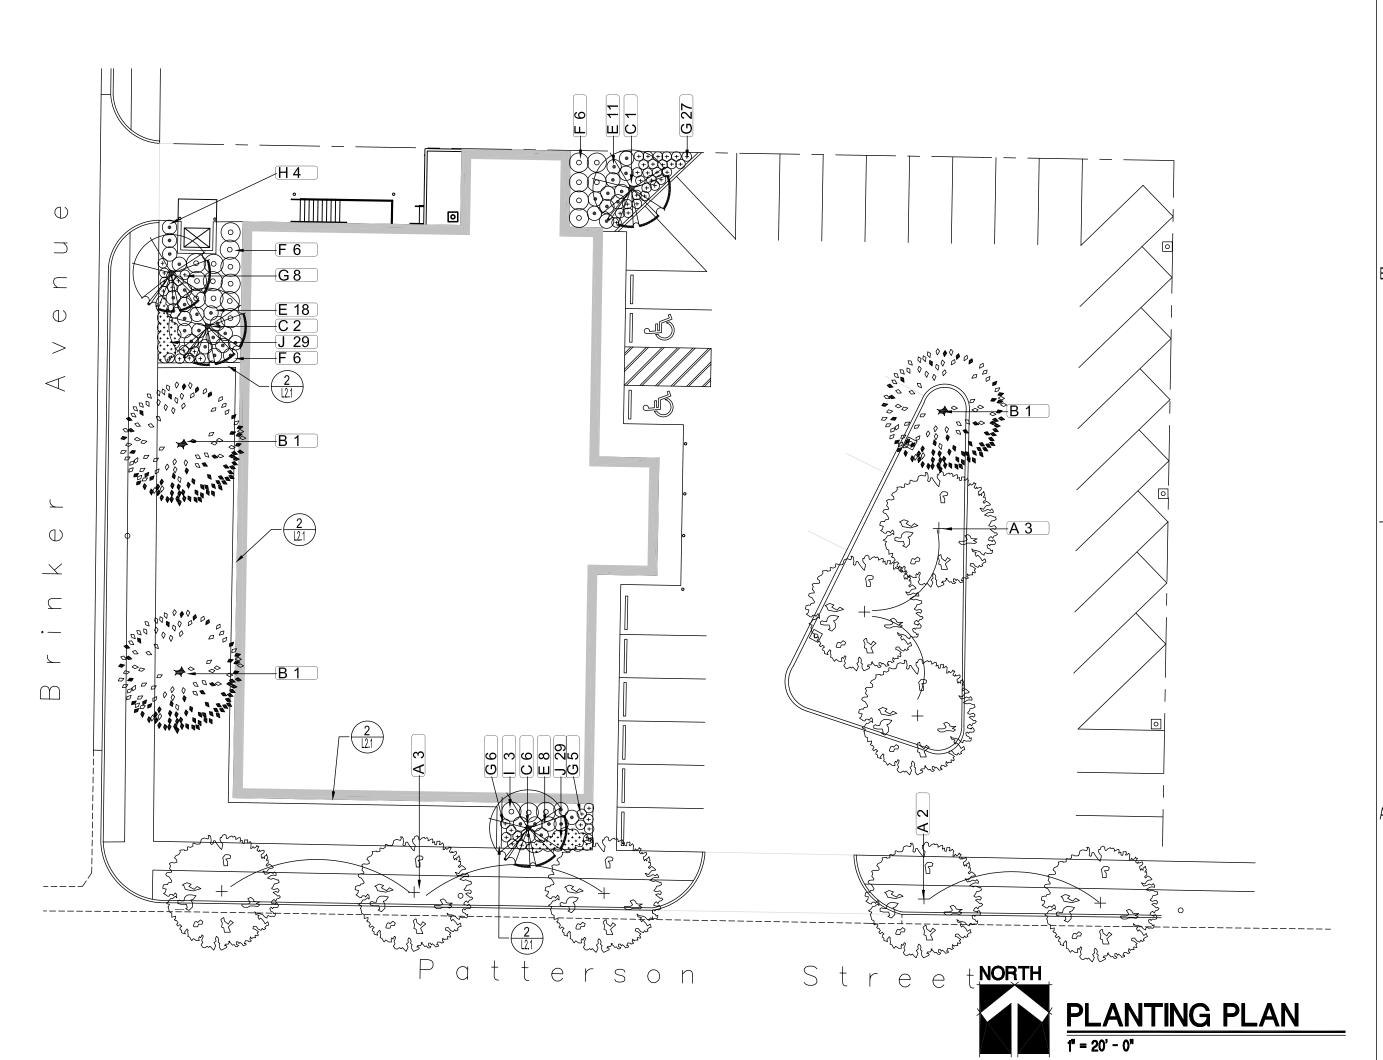





24

STORE

LIQUOR

PATTERSON

OGDEN

OGDEN, UTAH

OWNER

12-23-05

MARK DATE DESCRIPTION

PROJECT NUMBER: 2005-13

PROJECT NUMBER: 2005-13

DRAWING FILE:

DRAWN BY: BRENT


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SHEET TITLE

PLANTING & IRRIGATION PLANS

L1.1



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BEVERAGE CONTROL

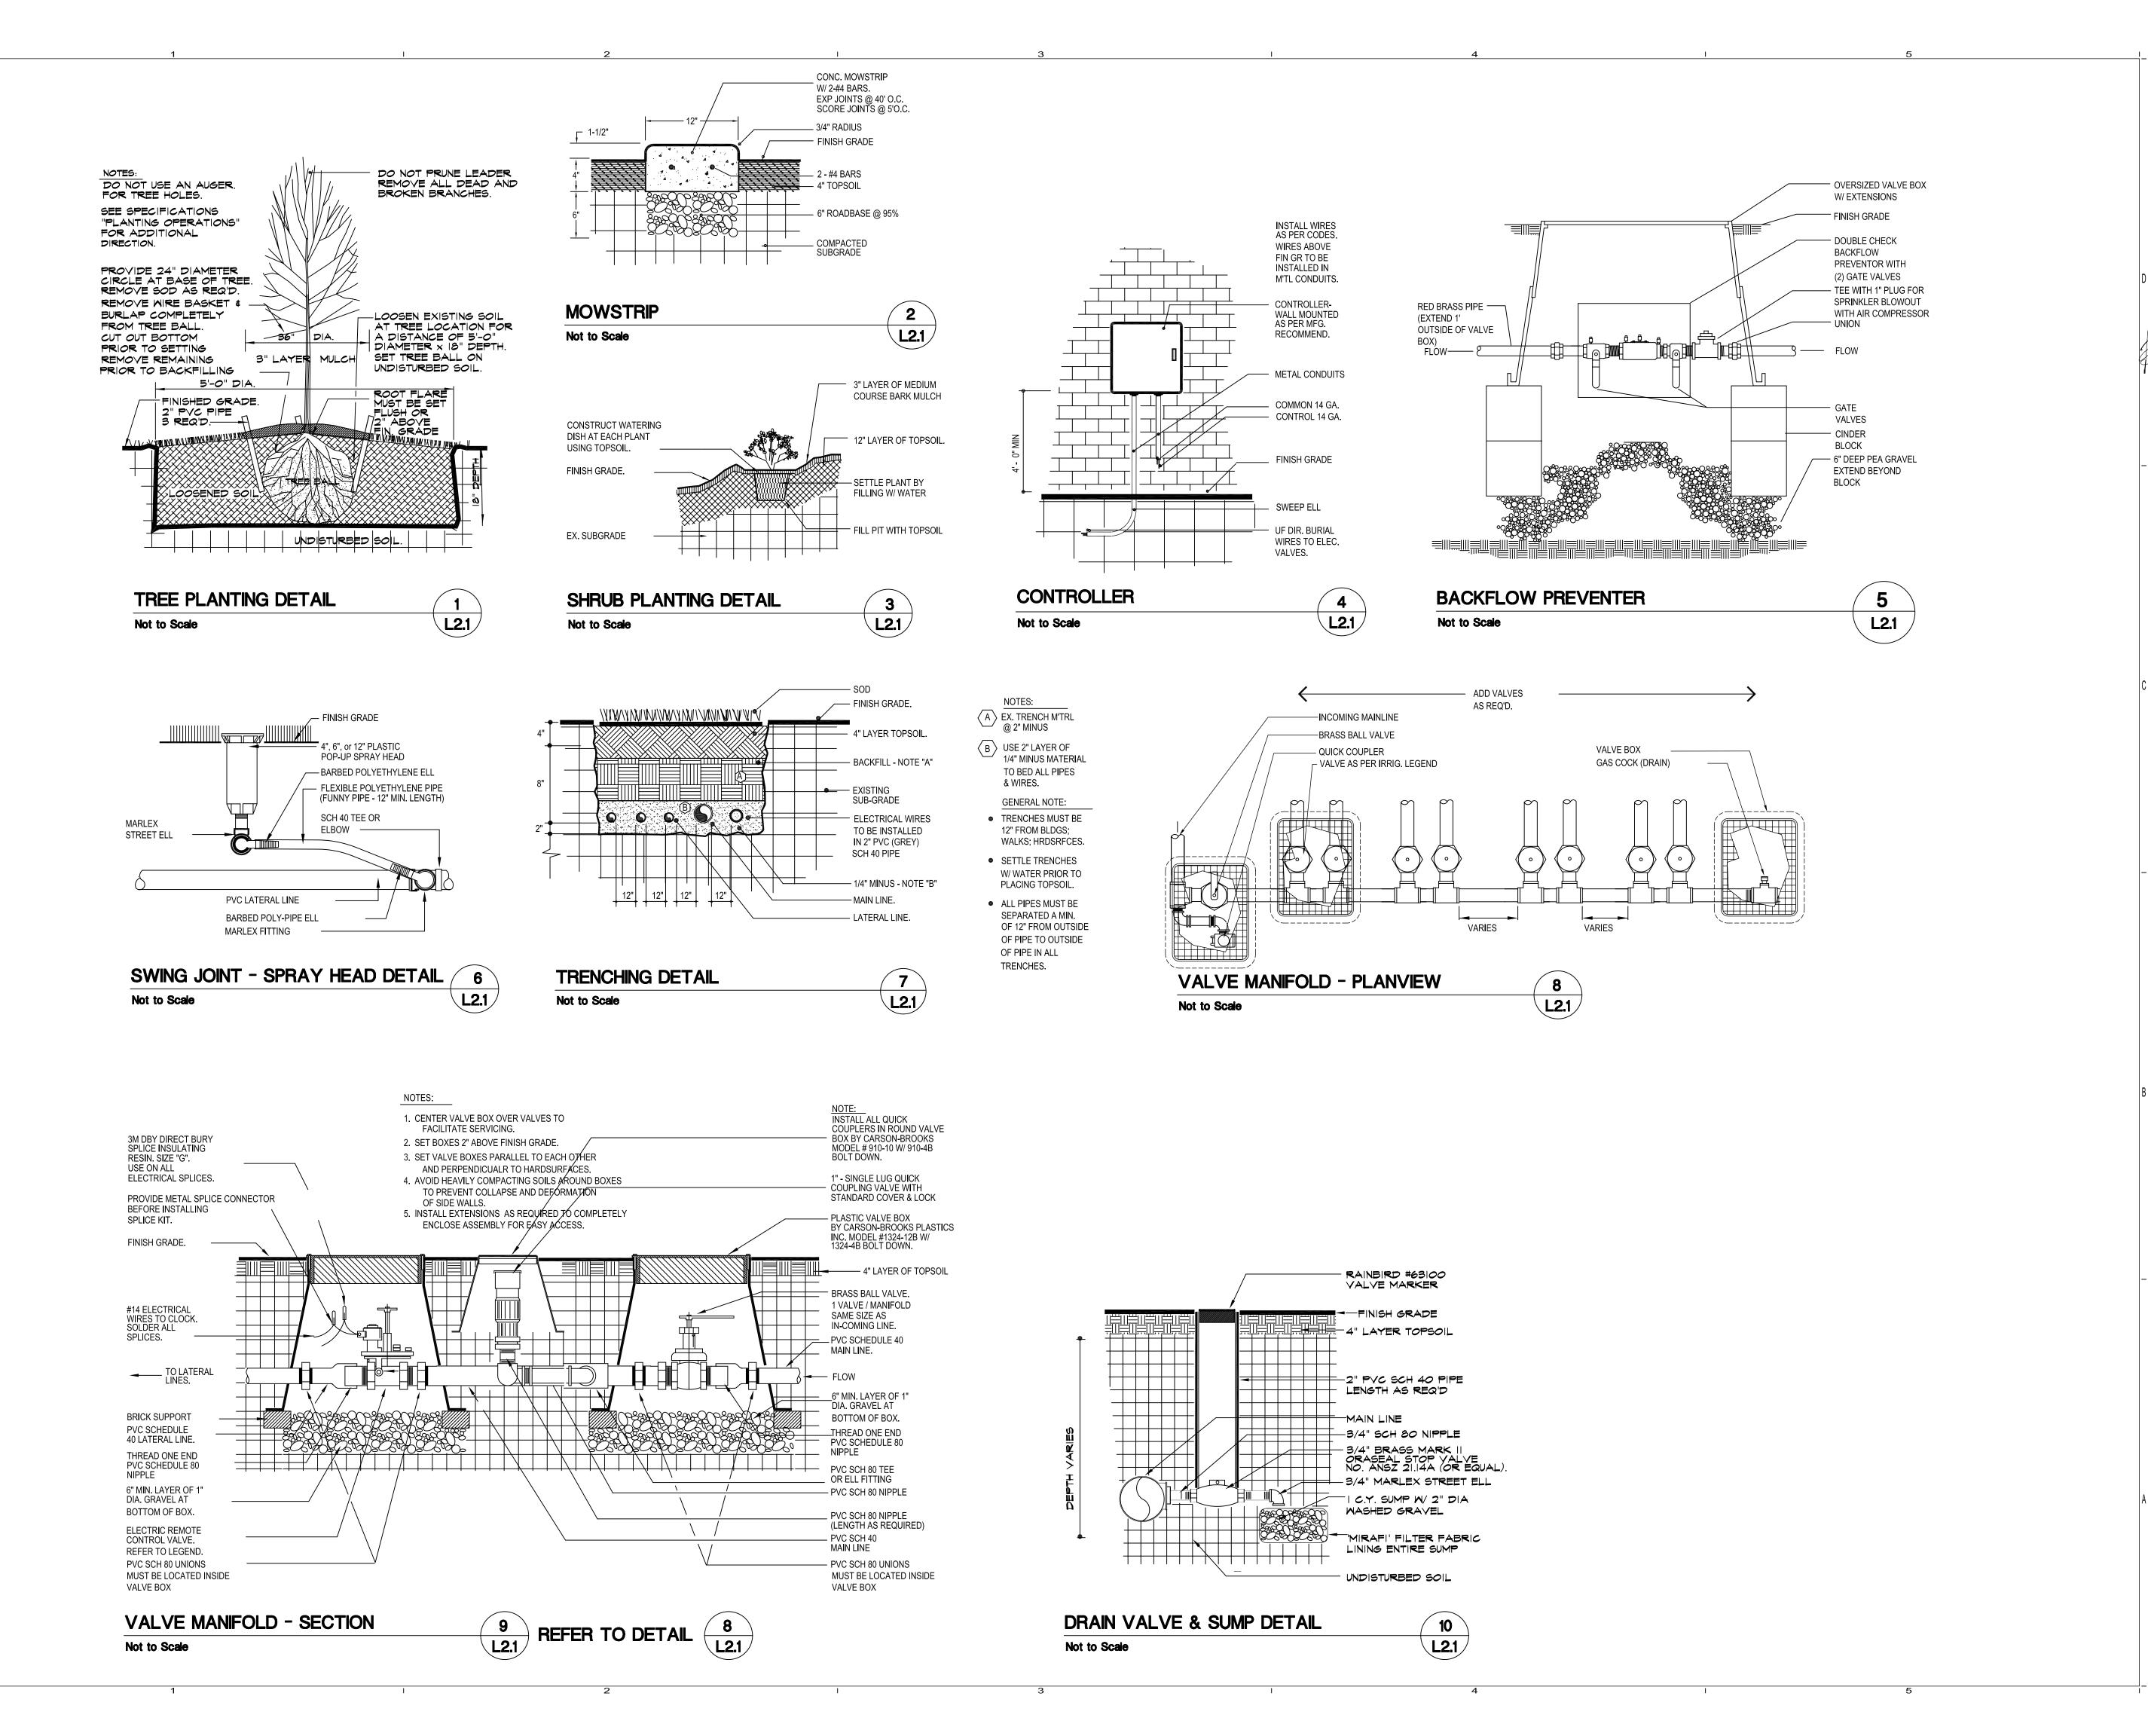OHOLIC

OWNER UTAH DEPARTMENT

2005-13

BRENT

BRENT

GDEN PATTERSON LIQUOR STORE # 24

12-23-05
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DRAWING FILE:
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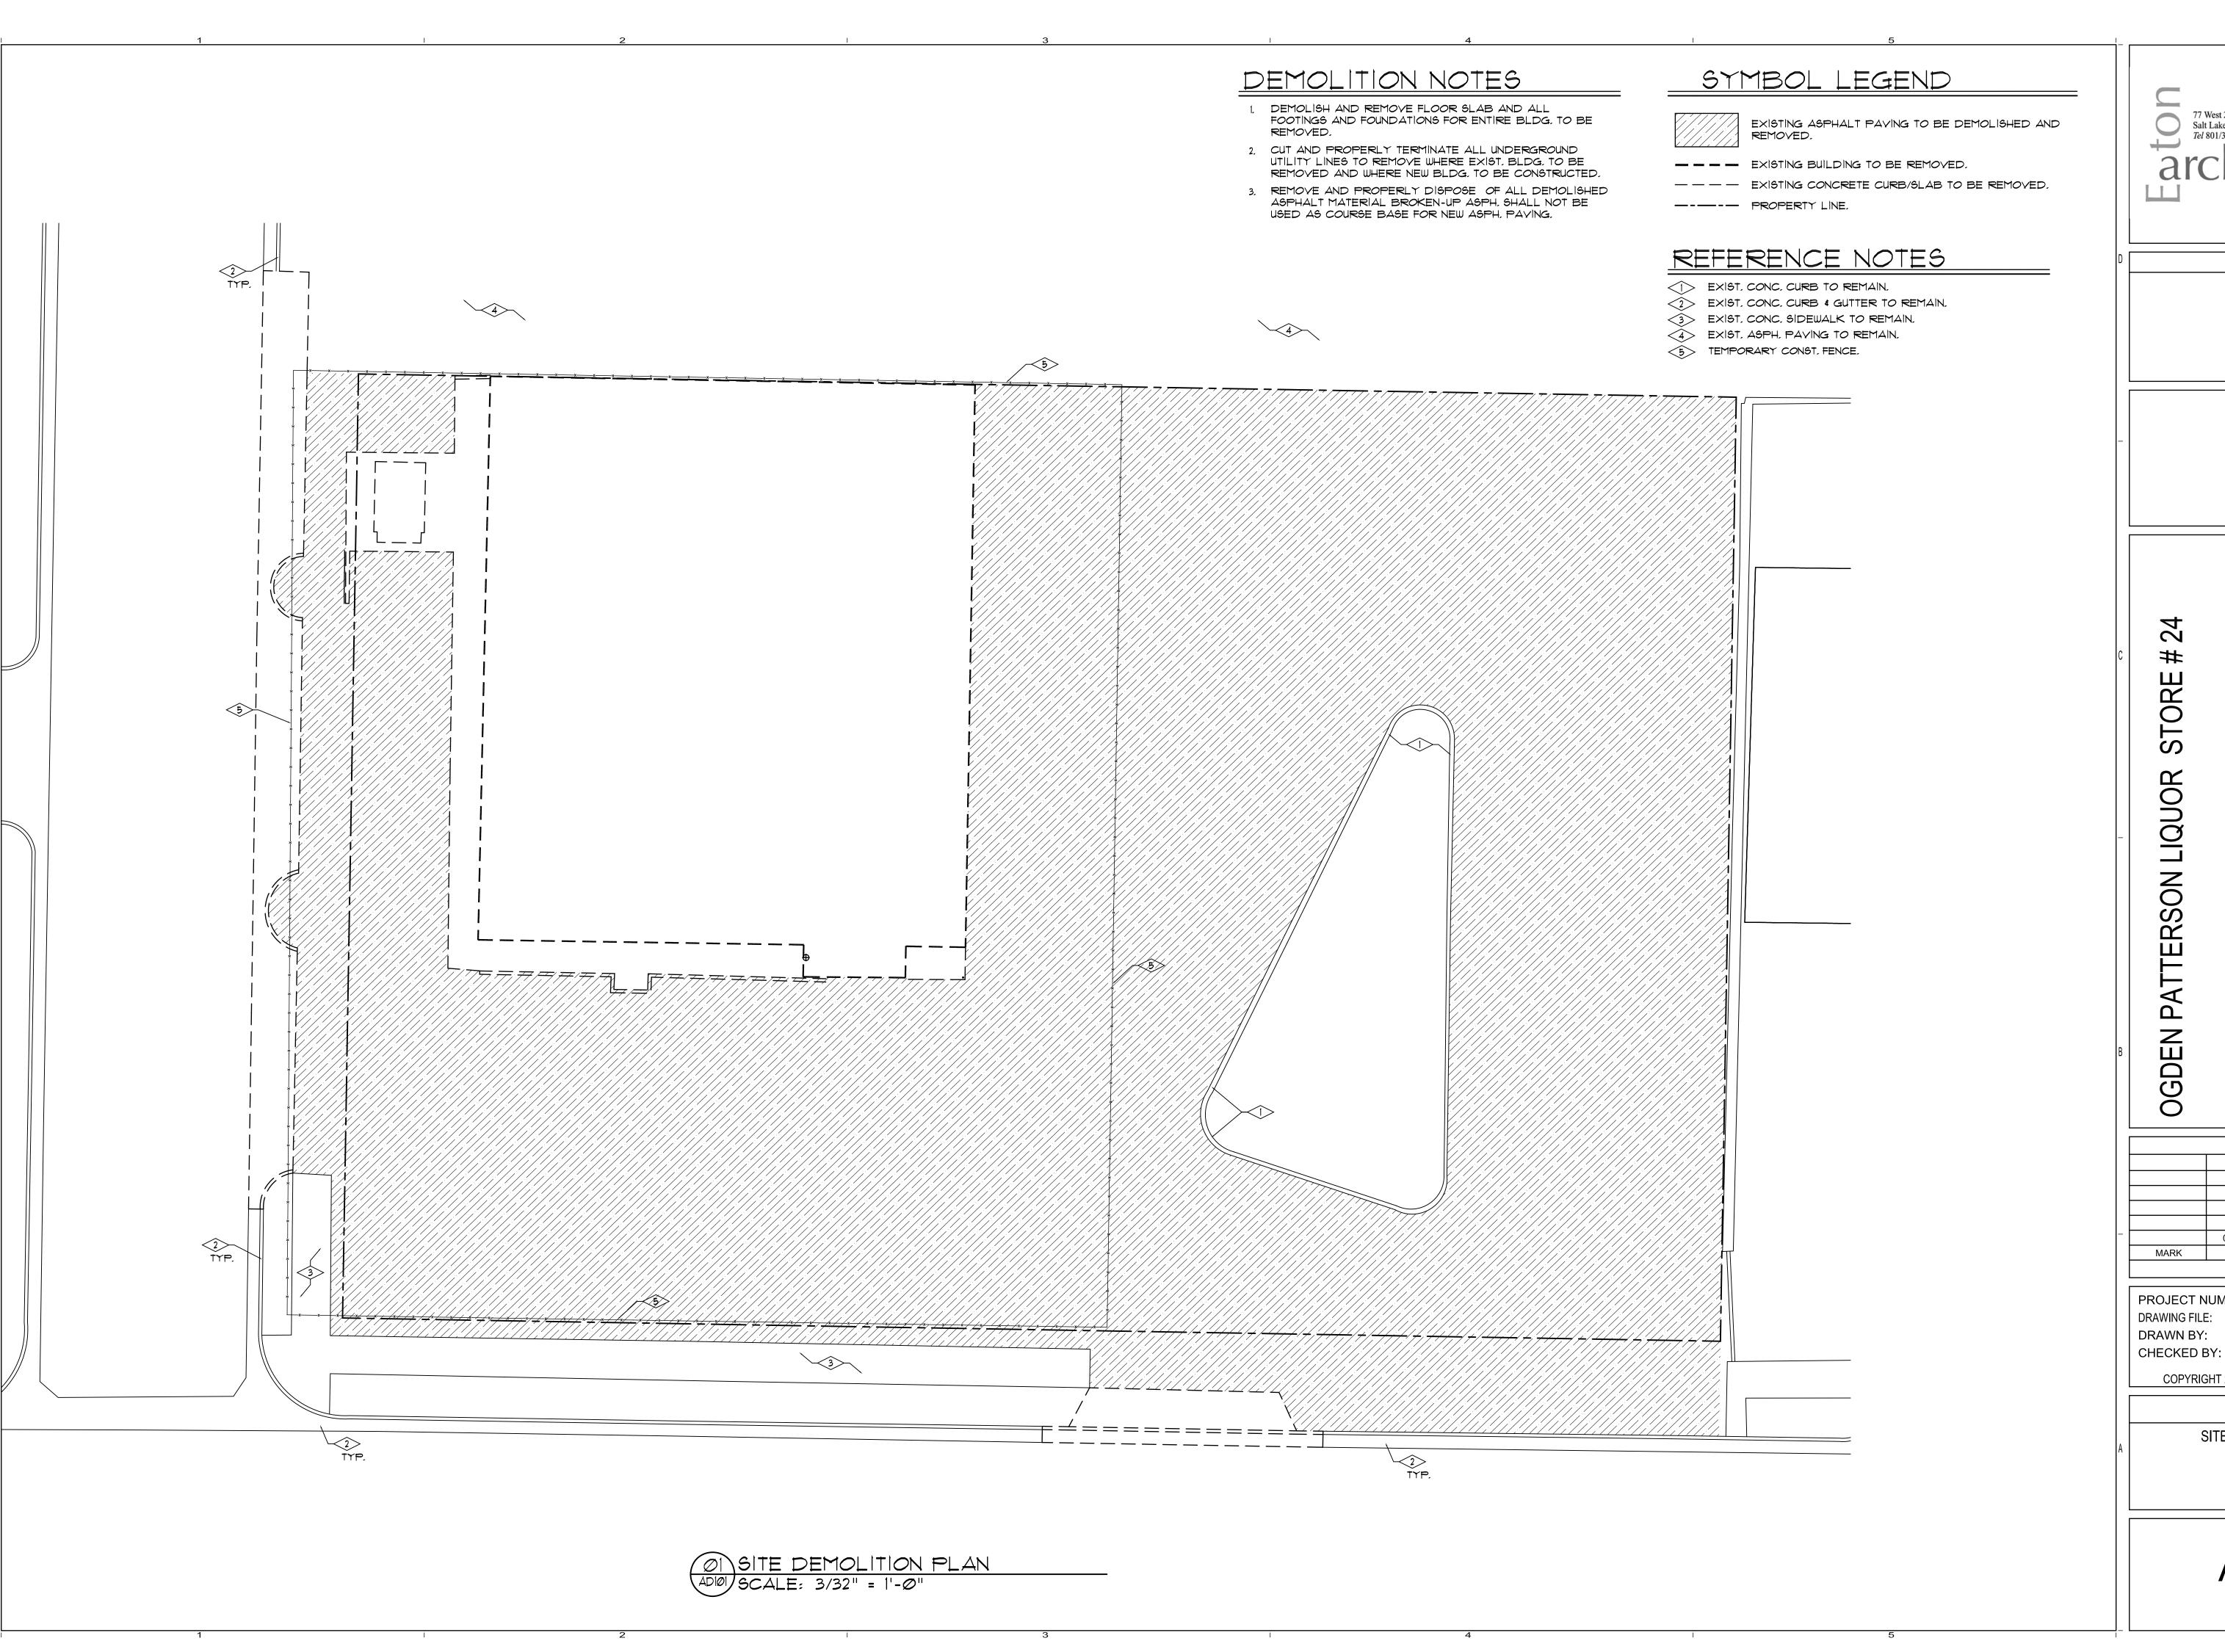
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SHEET TITLE

LANDSCAPE DETAILS


L2.

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DATE DESCRIPTION

PROJECT NUMBER:


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2005-13


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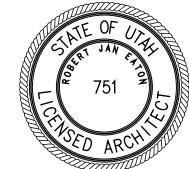
SITE DEMOLITION PLAN

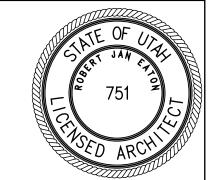
AD101






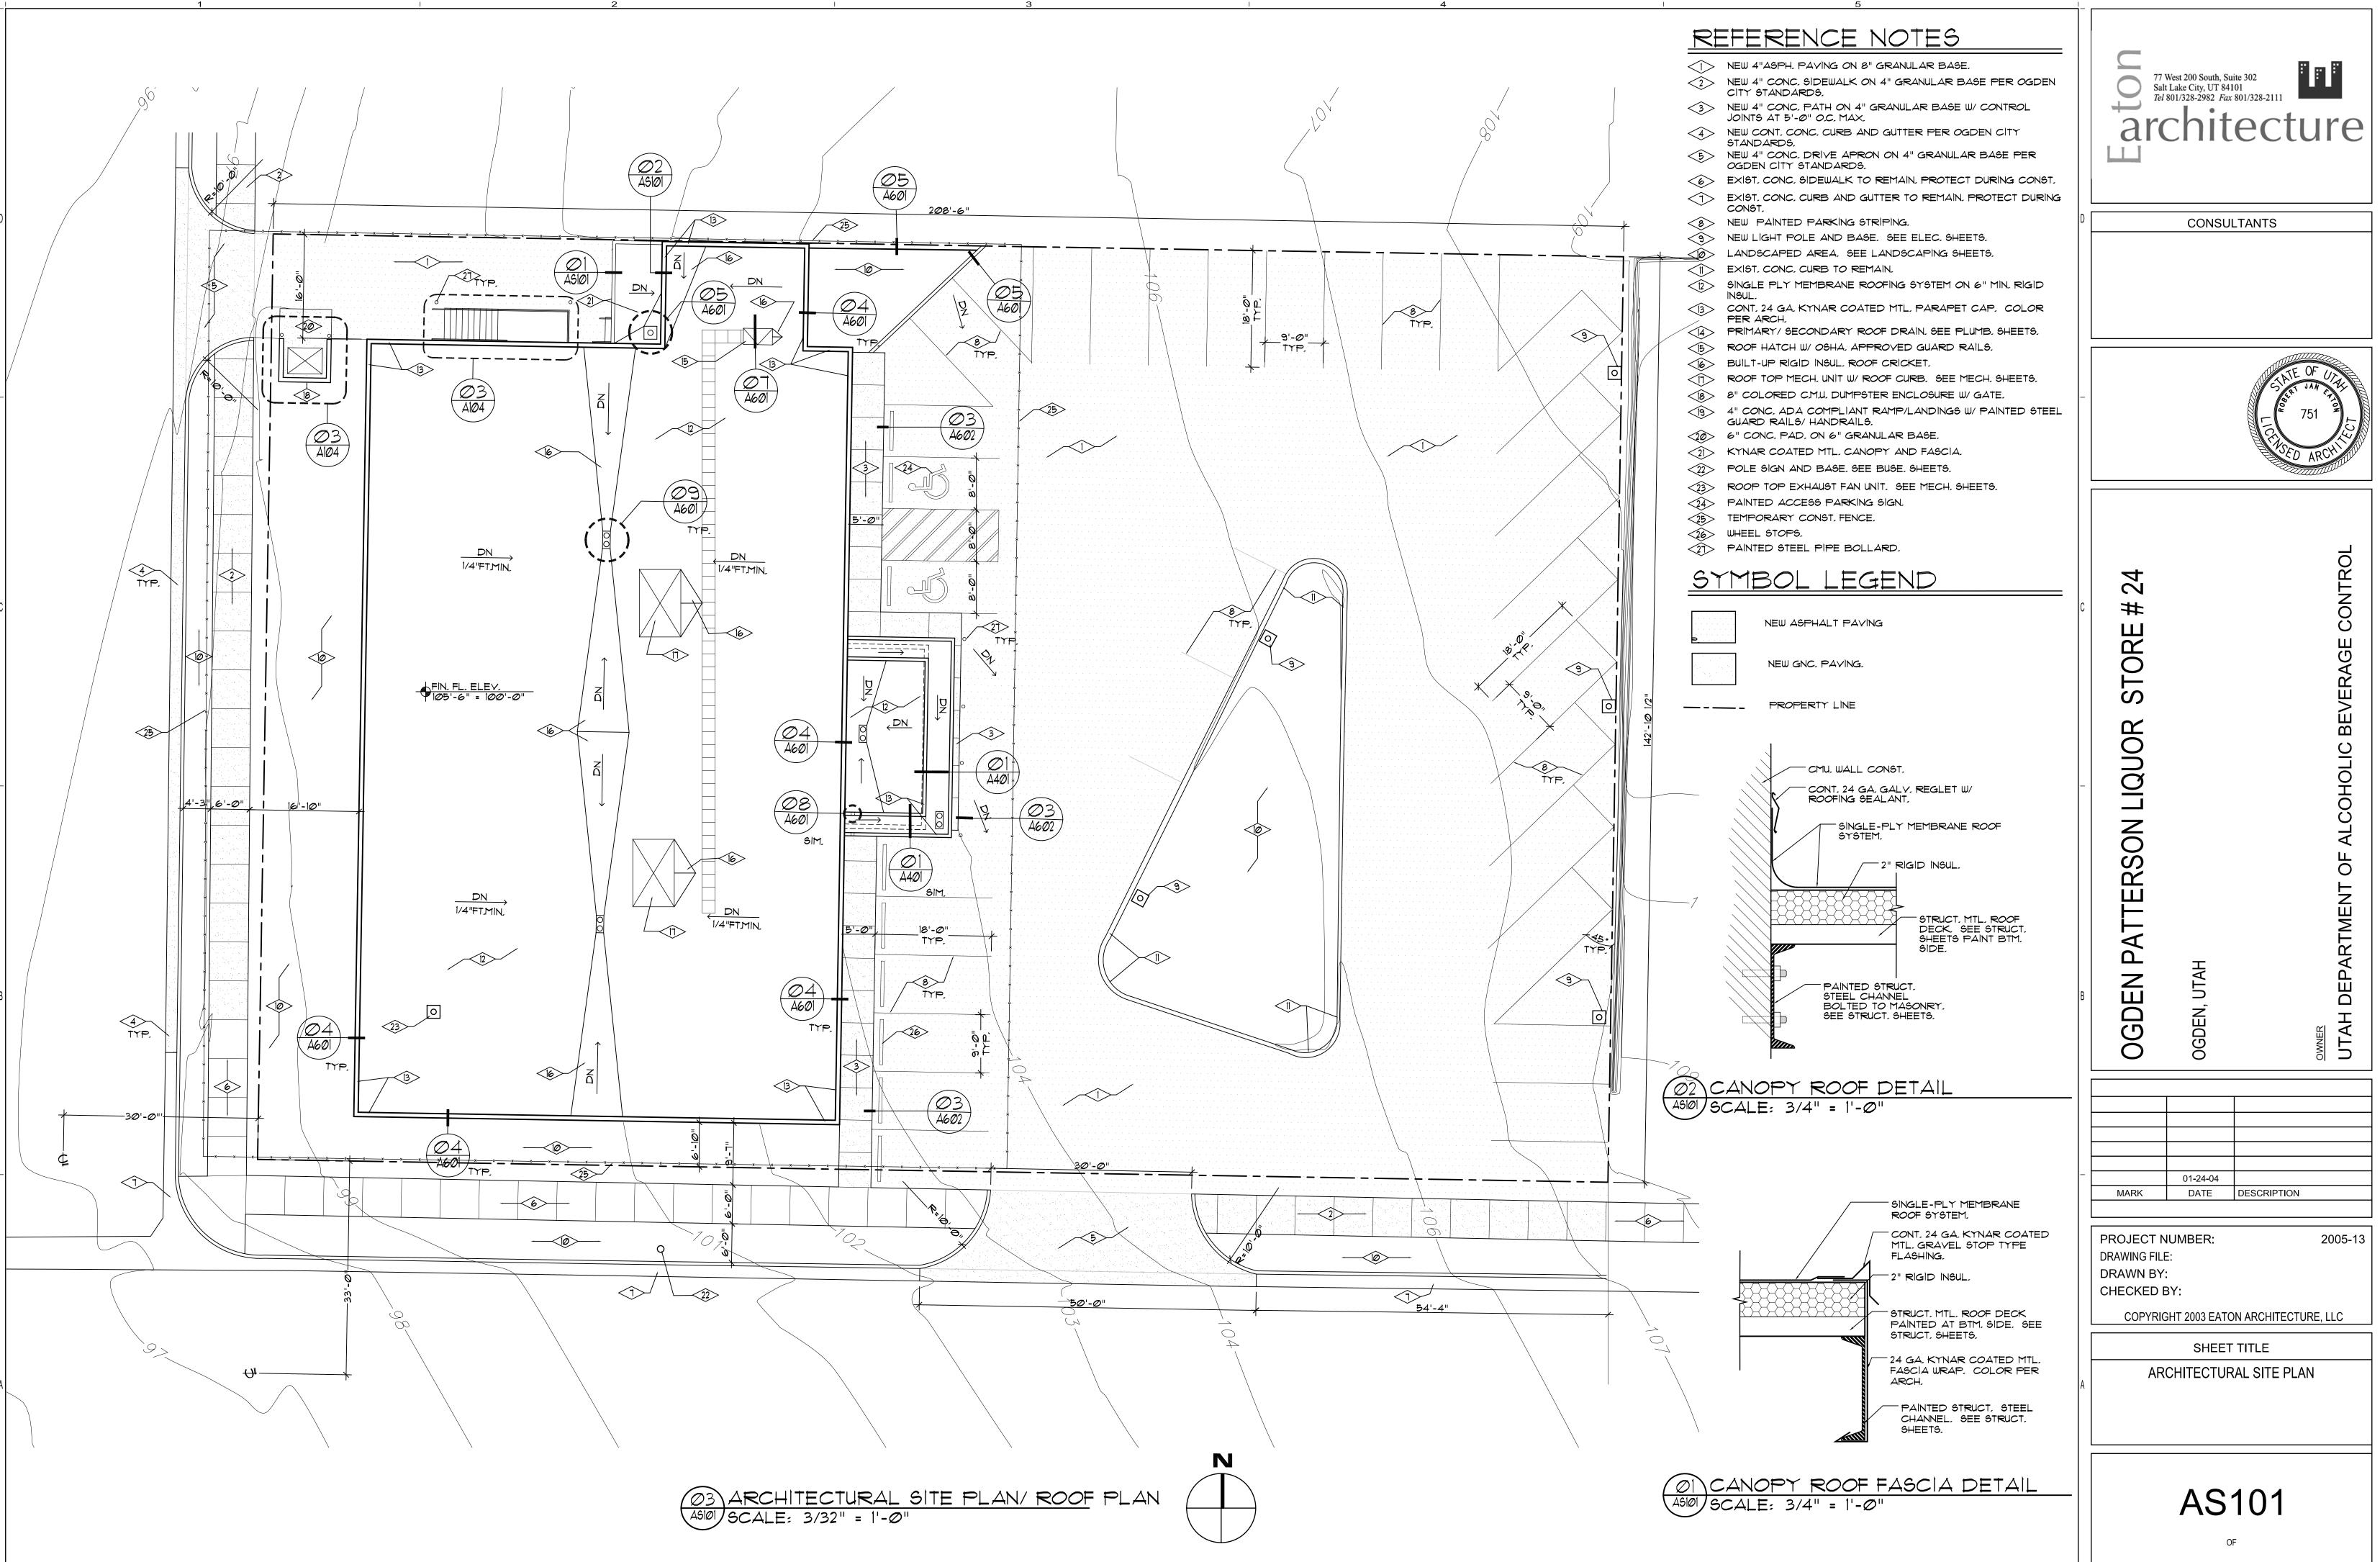

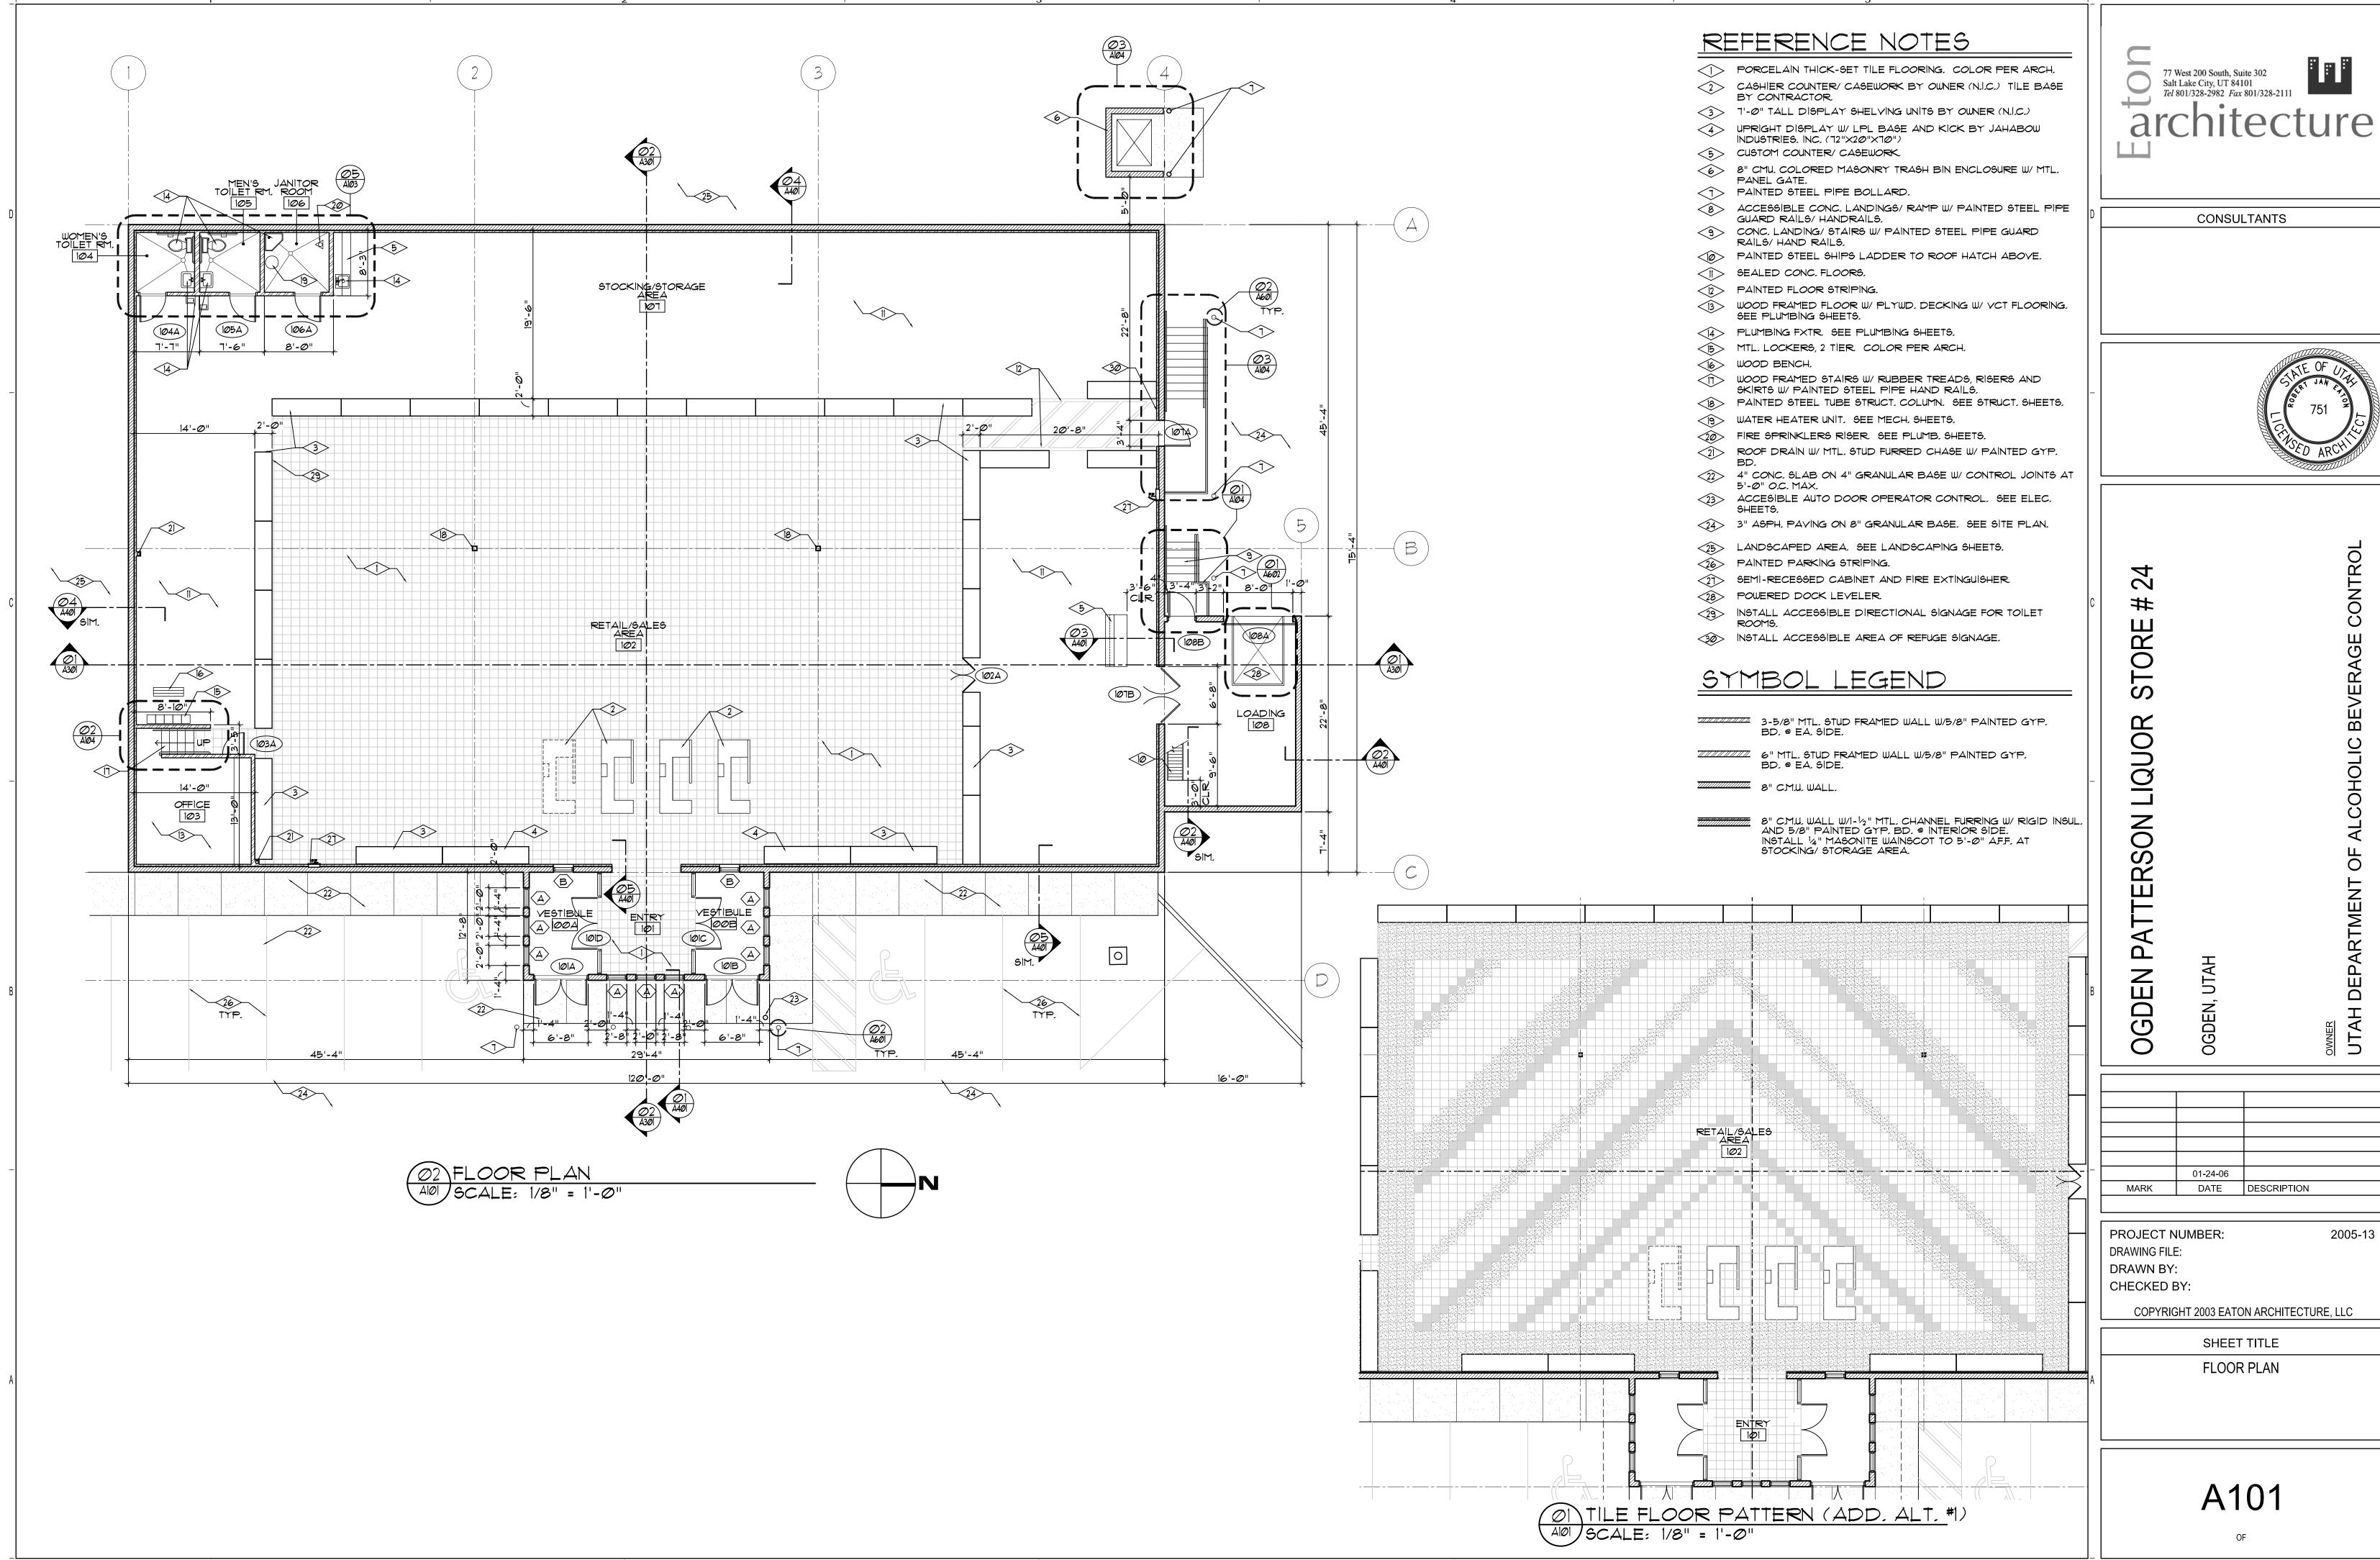

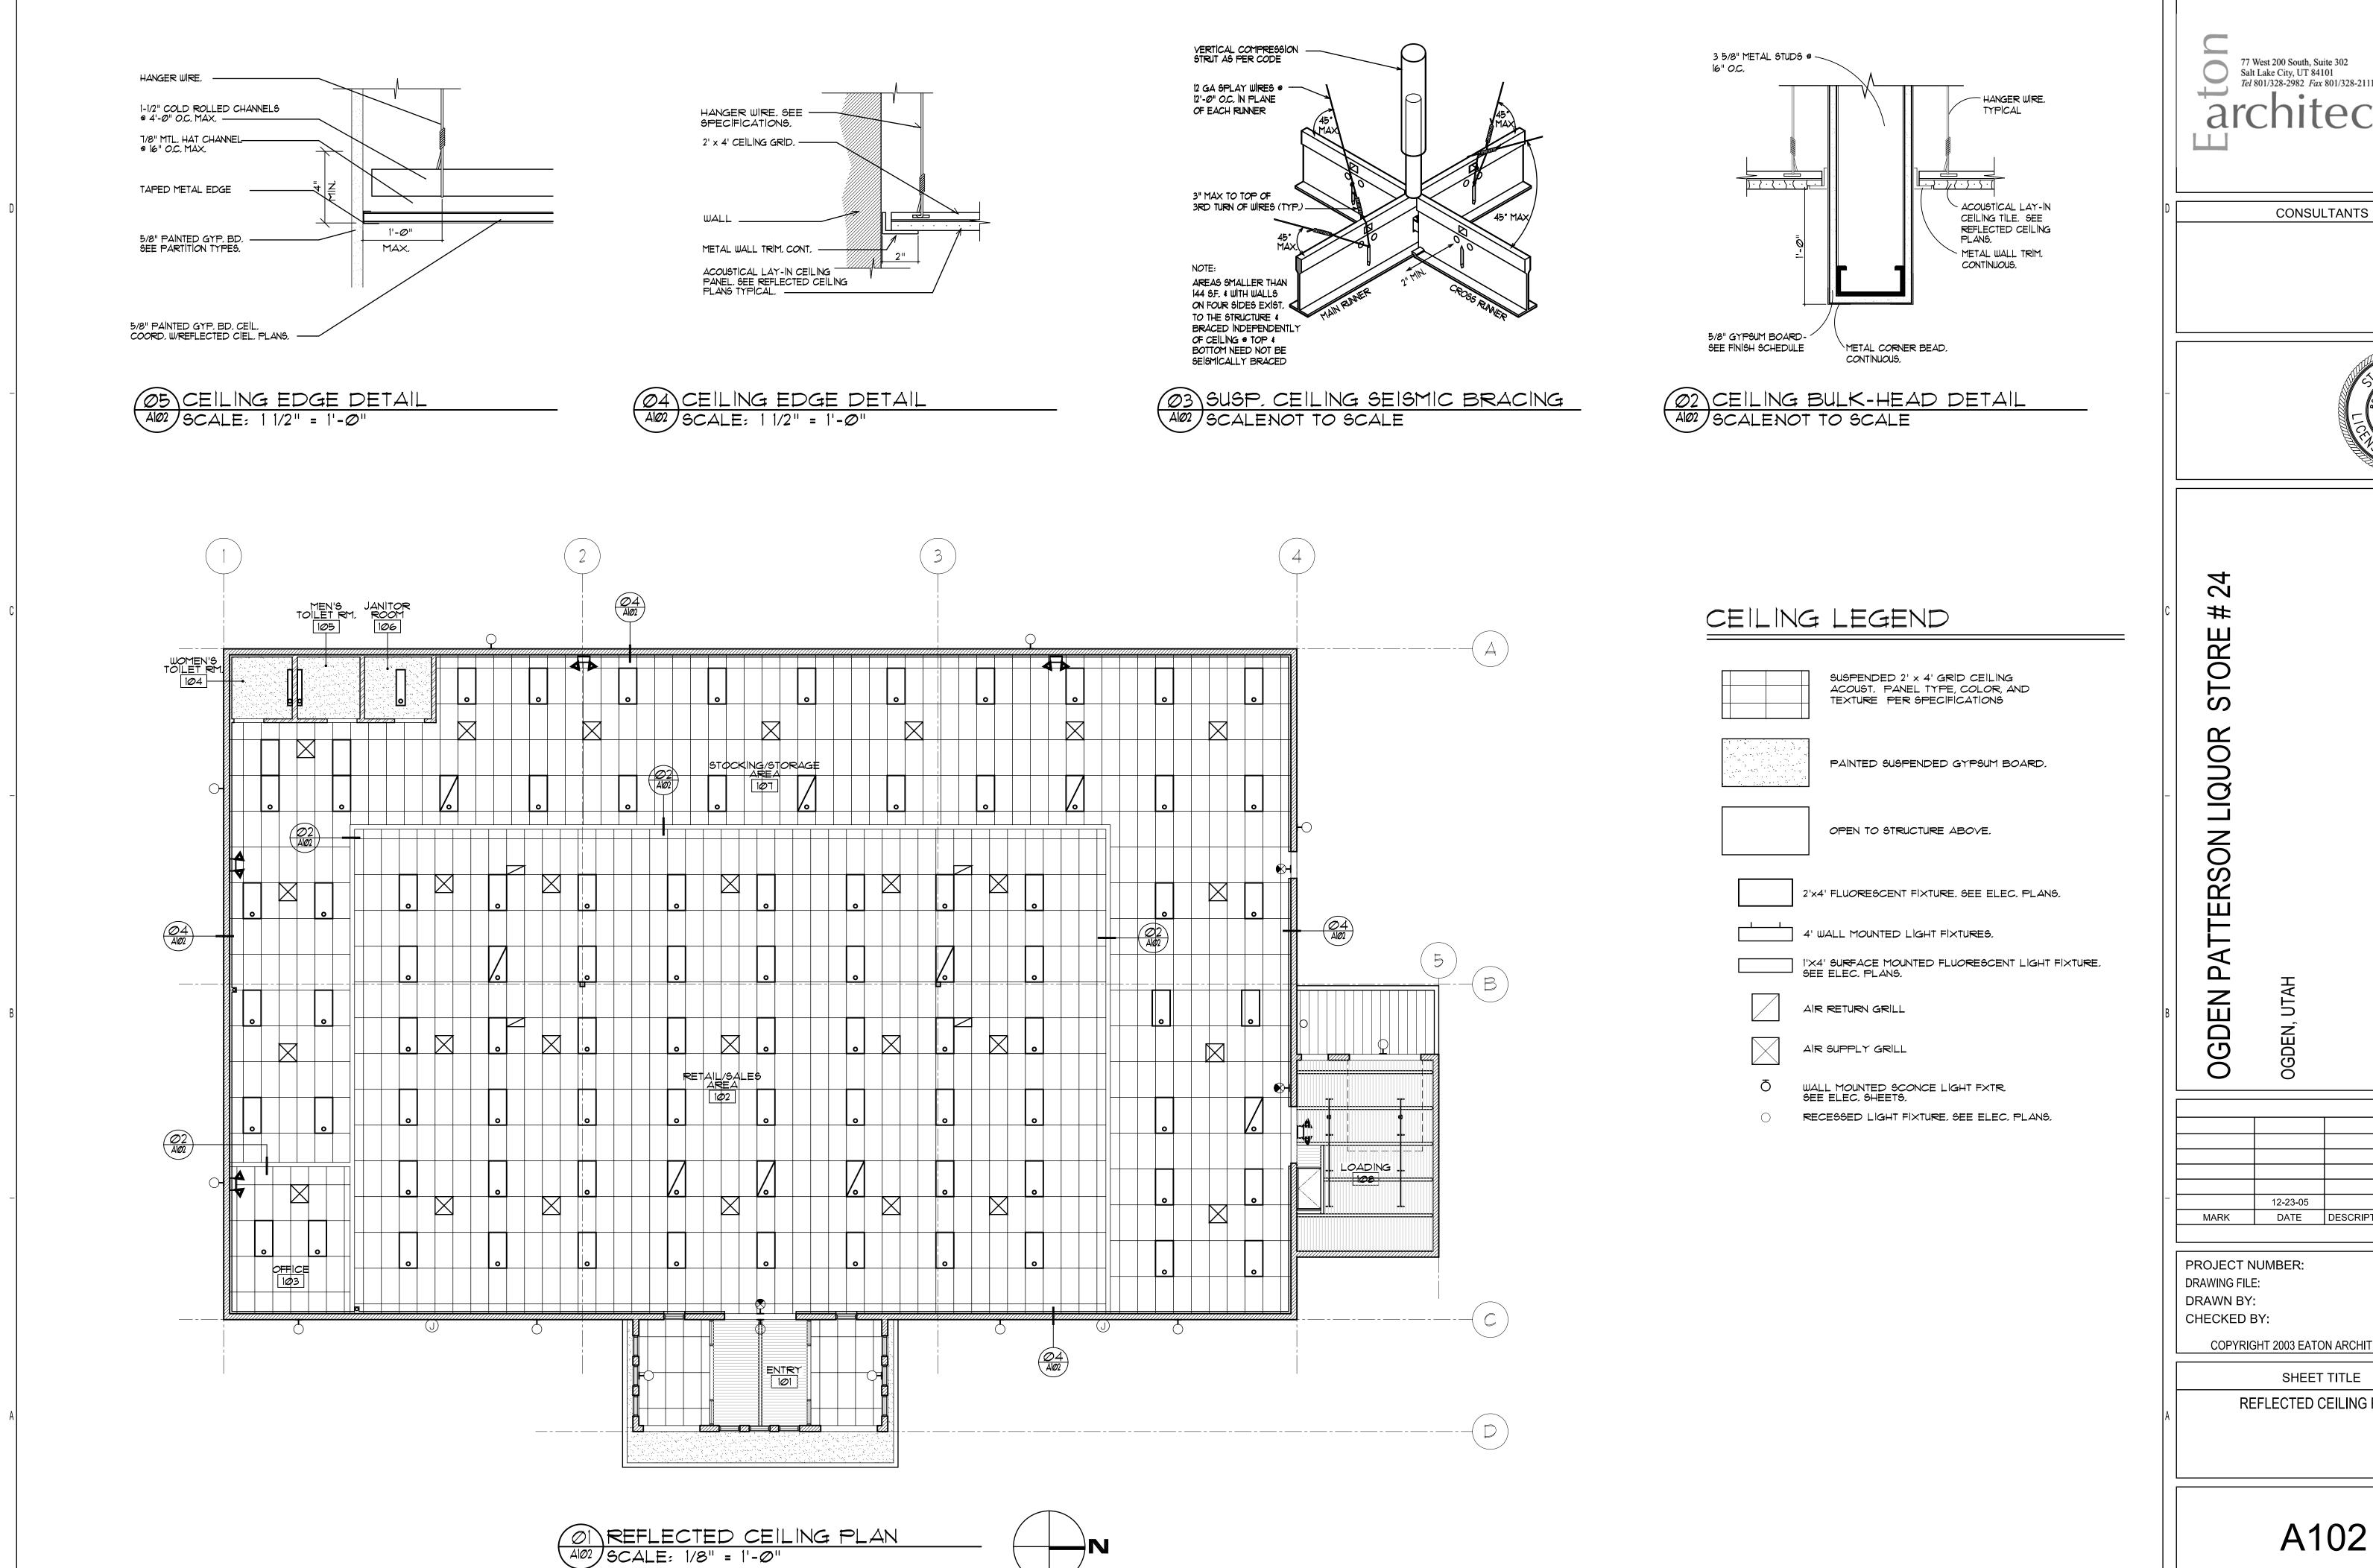

77 West 200 South, Suite 302 Salt Lake City, UT 84101 Tel 801/328-2982 Fax 801/328-2111 architecture

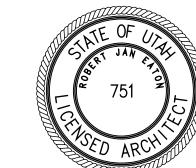

OHOLIC BEVERAGE CONTROL OWNER
UTAH DEPARTMENT OF ALC


DATE DESCRIPTION

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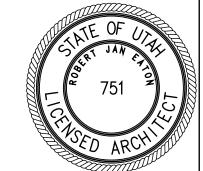
2005-13

SHEET TITLE

REFLECTED CEILING PLAN

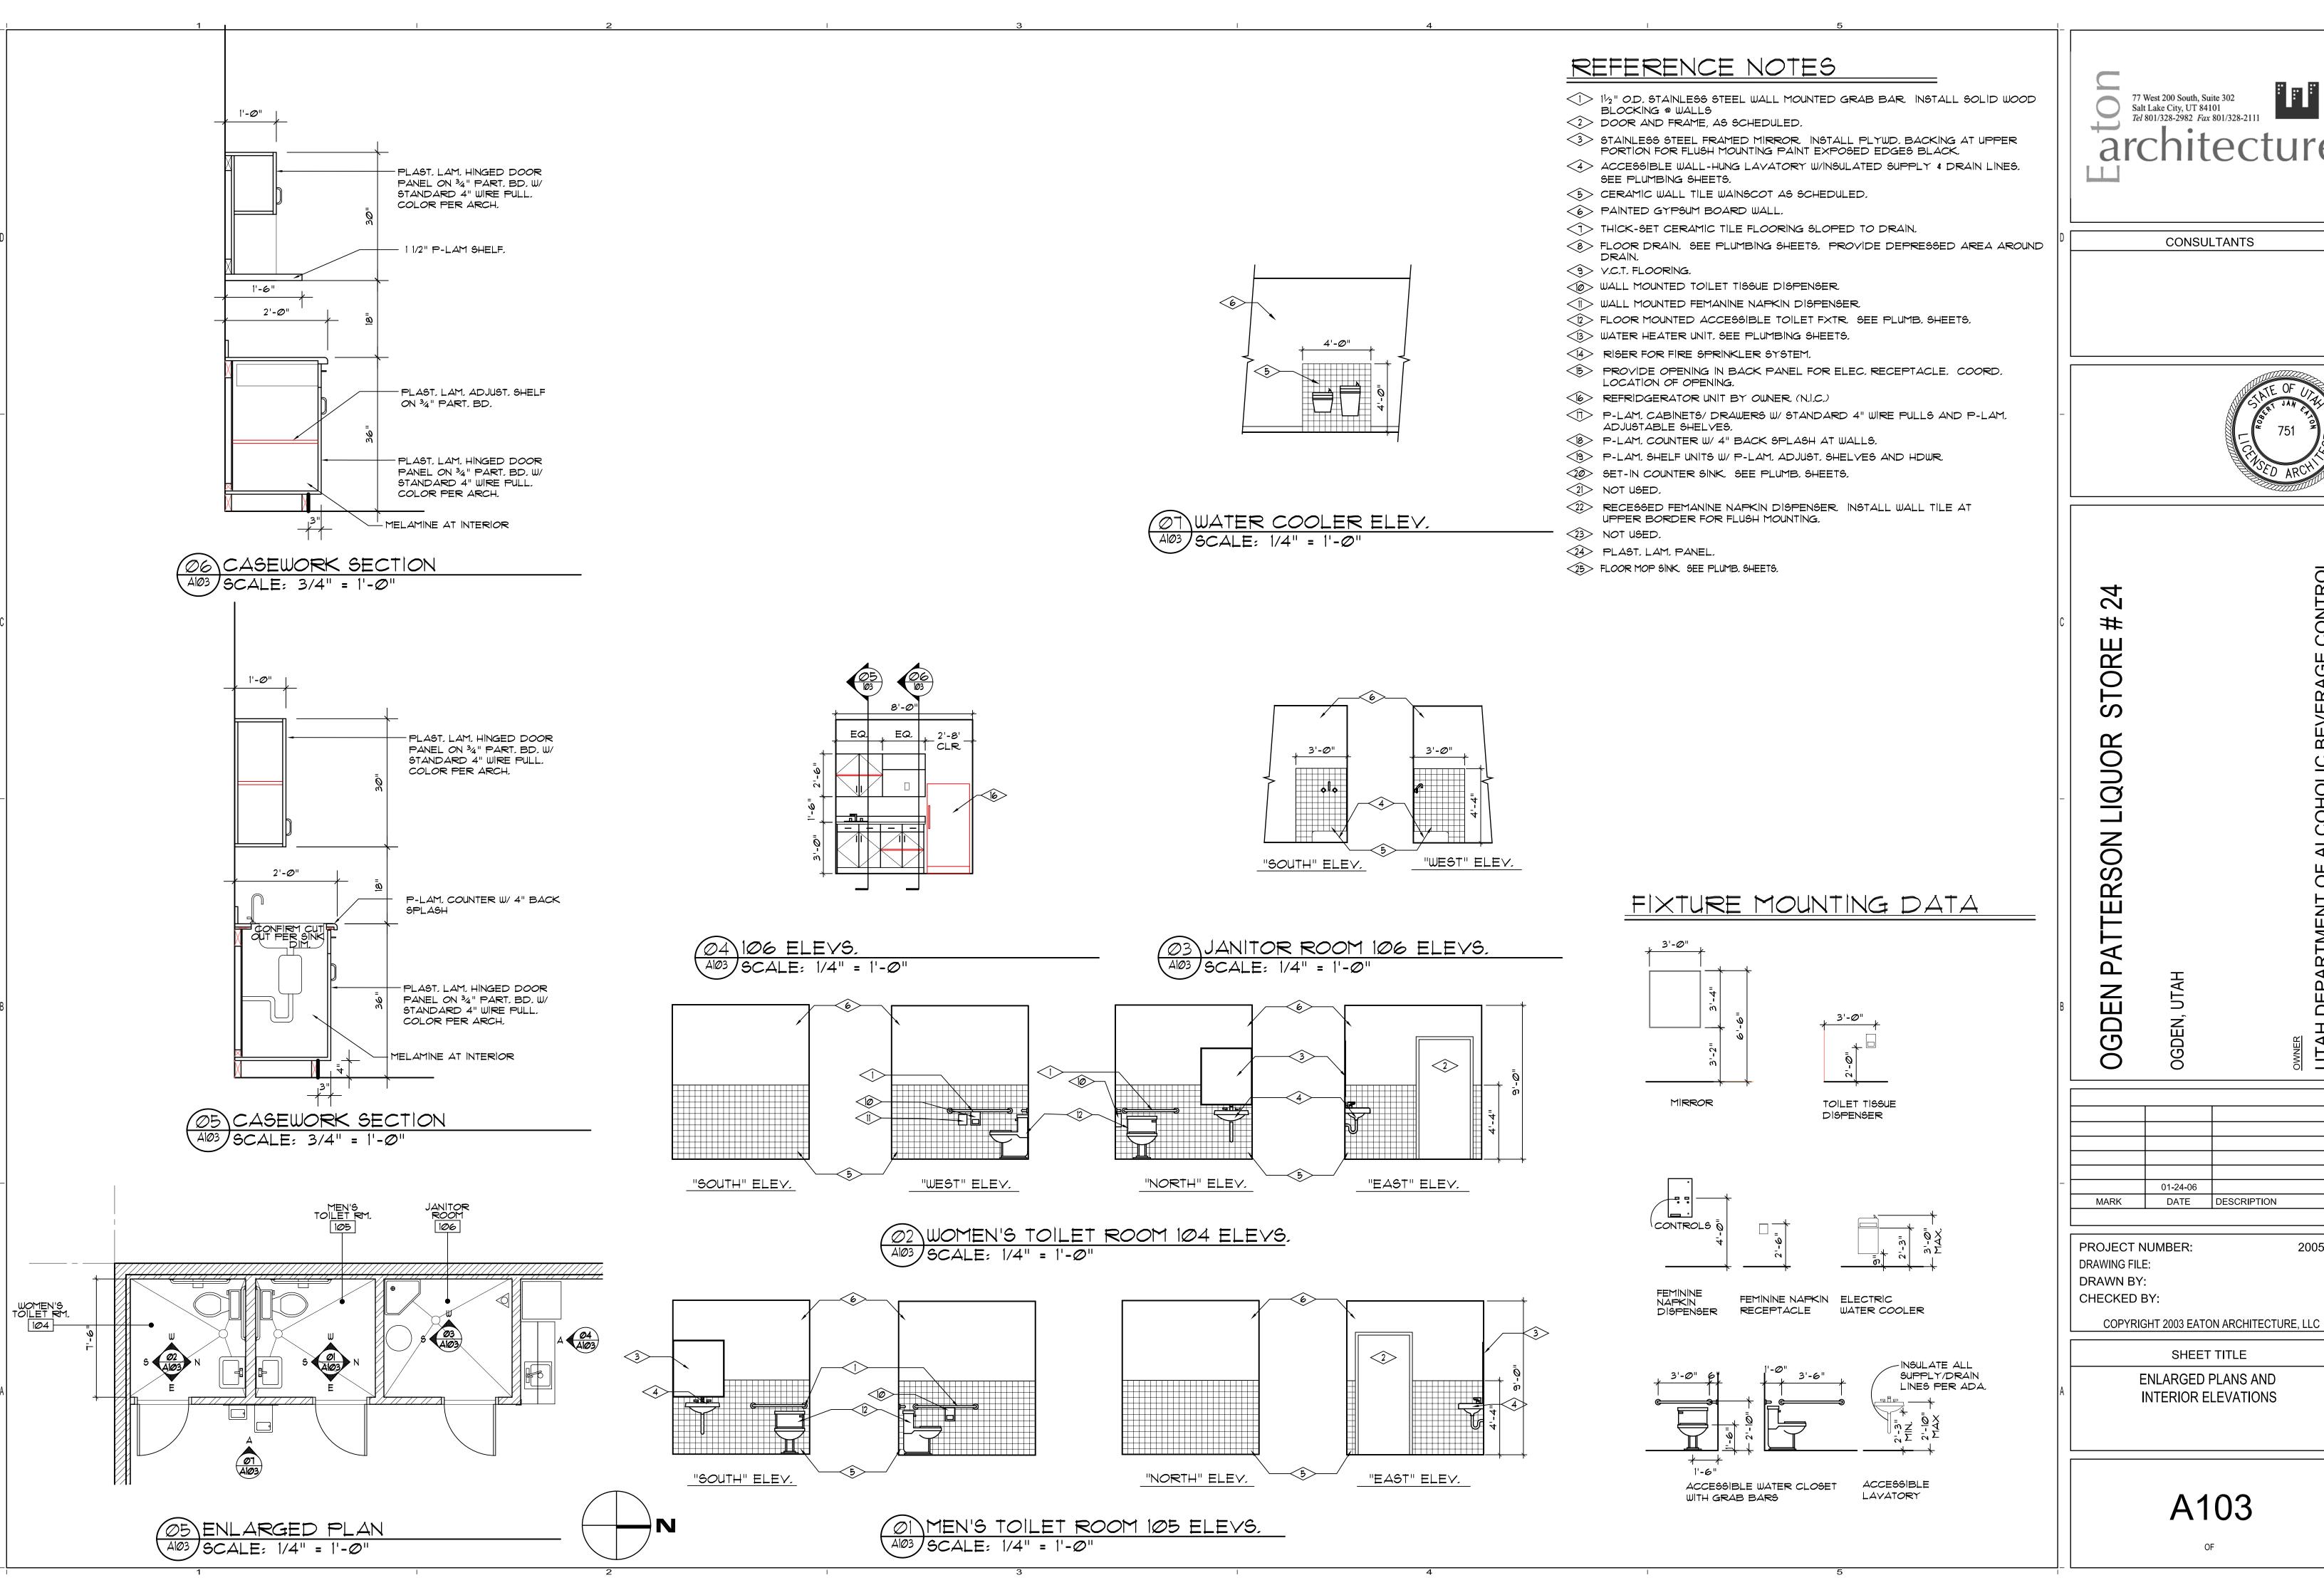

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CONTRO

BEVERAGE


2005-13

UTAH DEPARTMENT OF AL

DESCRIPTION


SHEET TITLE

ENLARGED PLANS AND INTERIOR ELEVATIONS

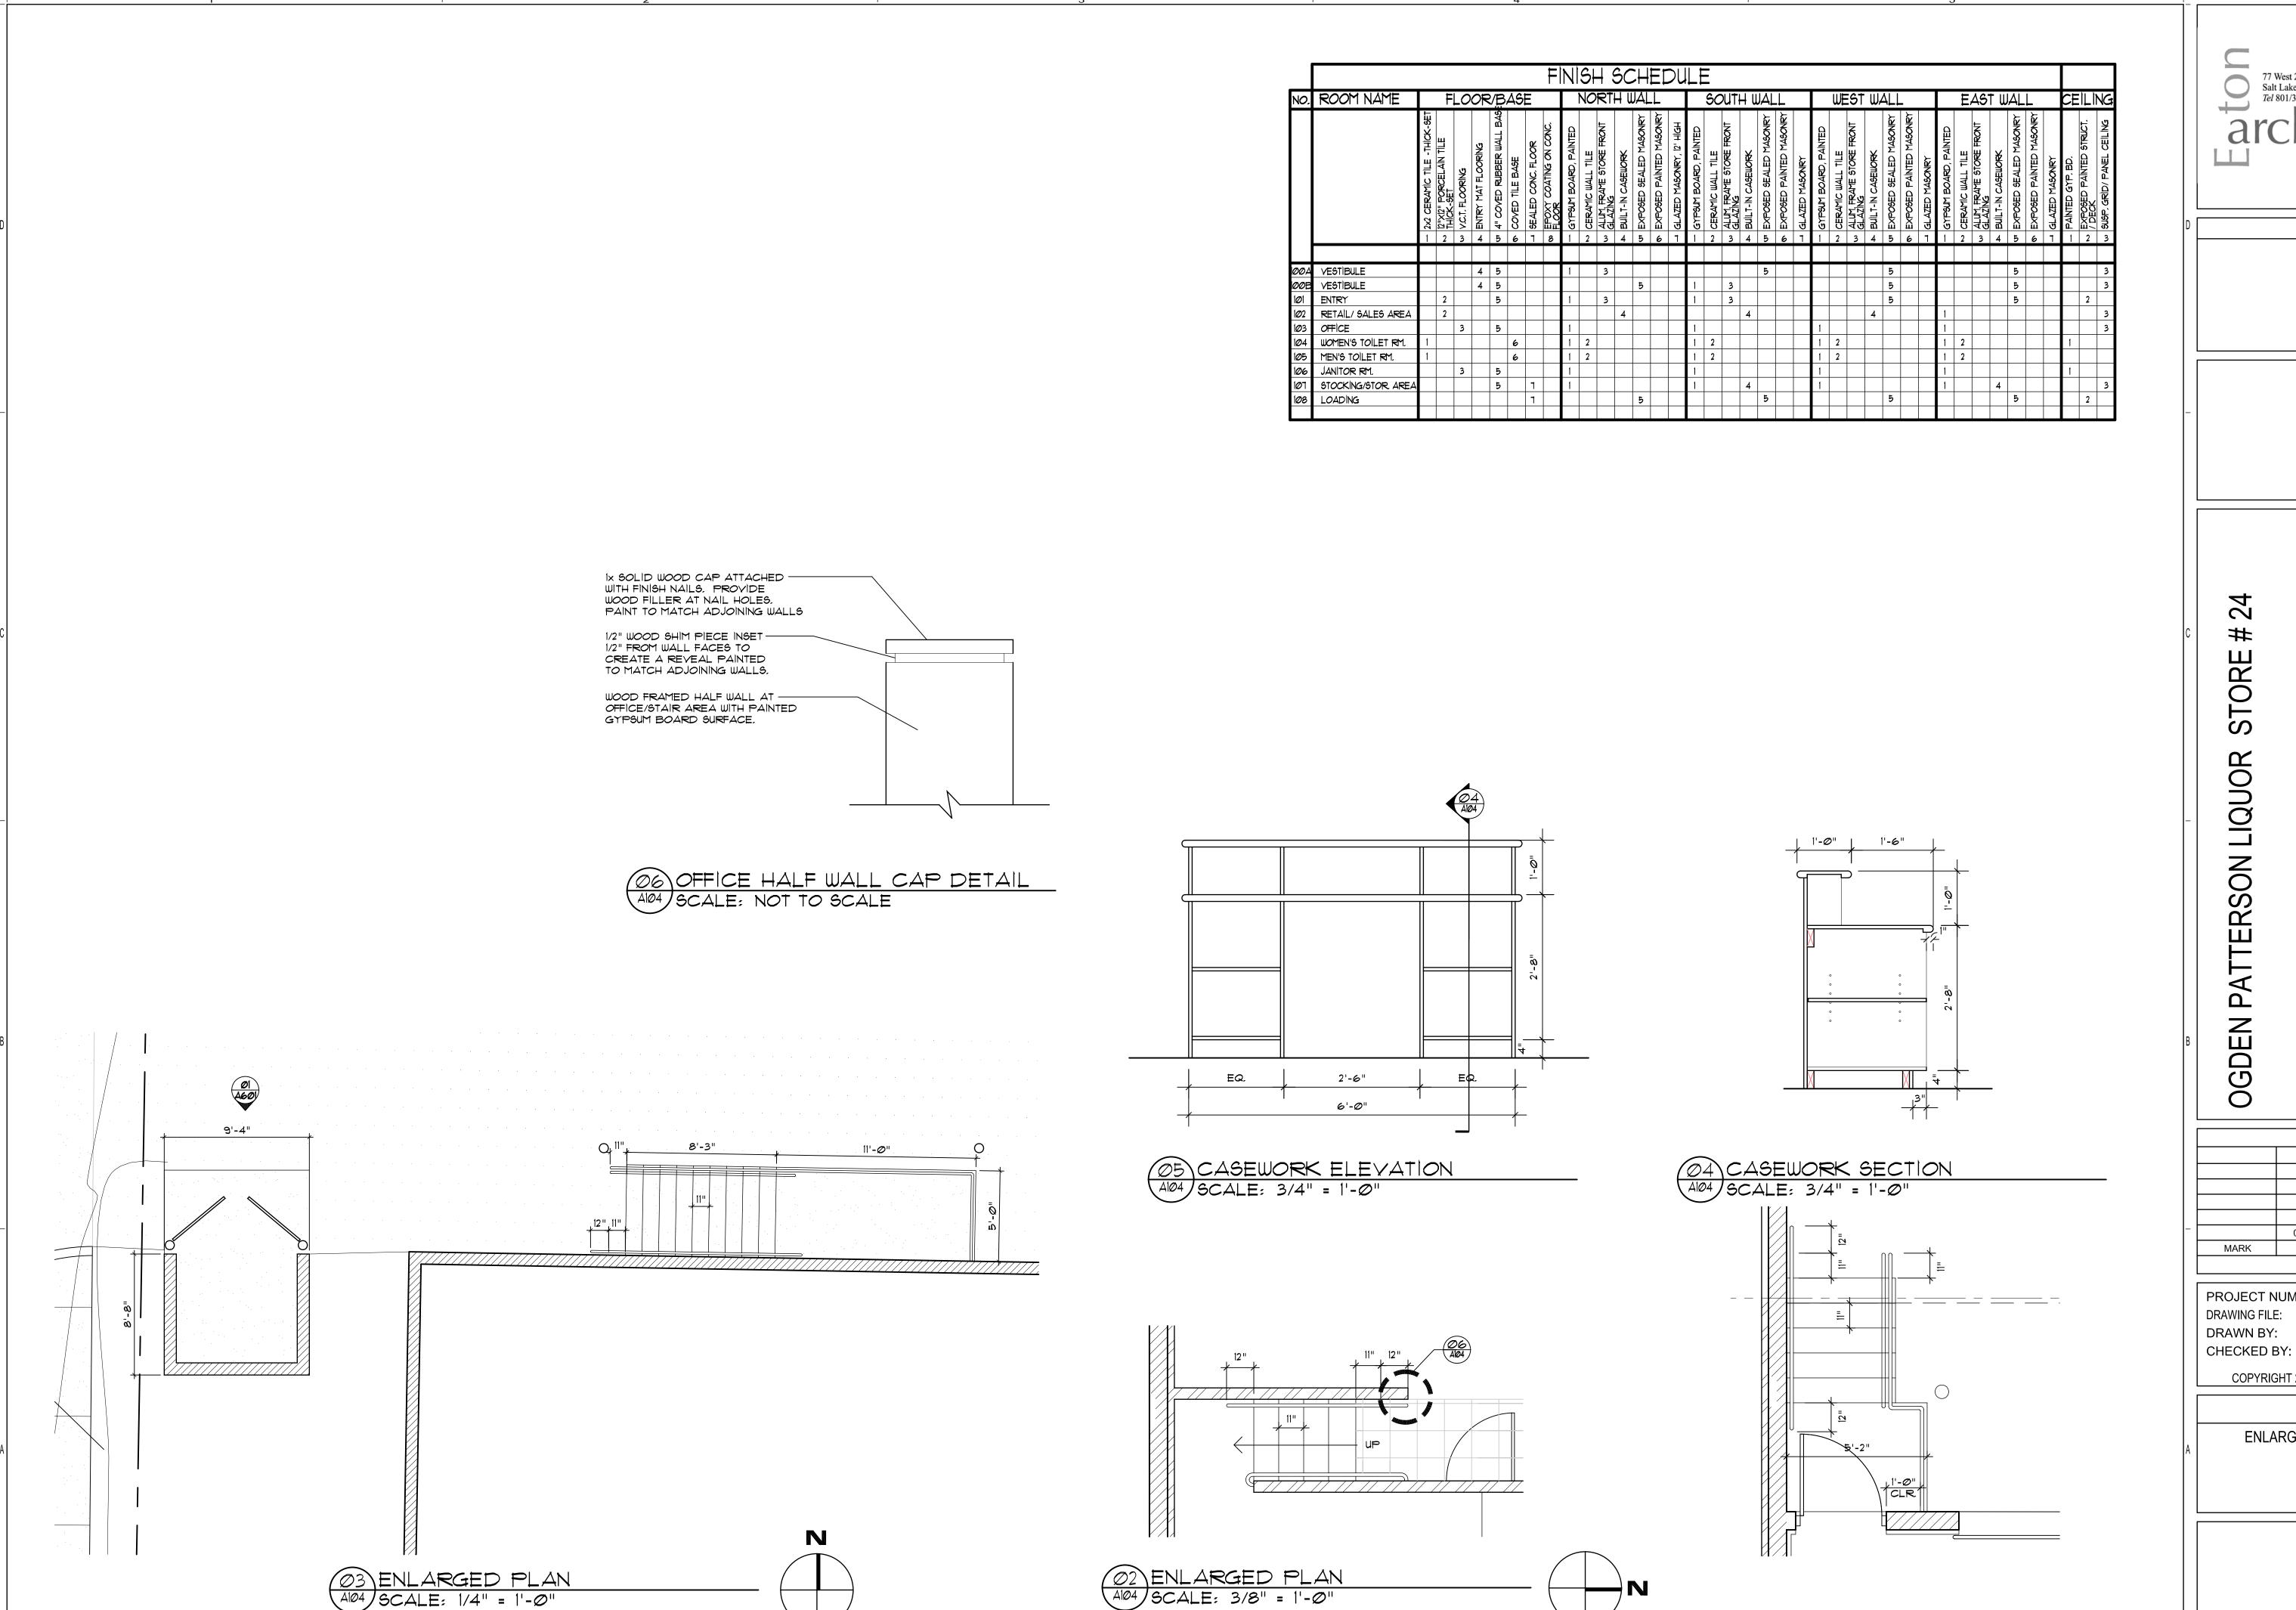



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OHOLIC BEVERAGE CONTROL

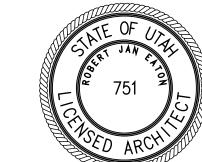01-24-06 DATE DESCRIPTION MARK


2005-13

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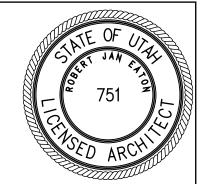
SHEET TITLE

ENLARGED STAIR/ RAMP PLANS



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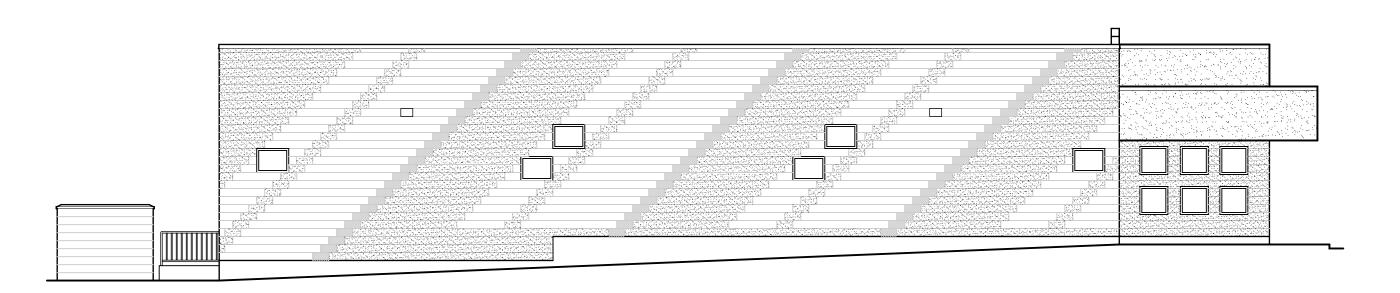
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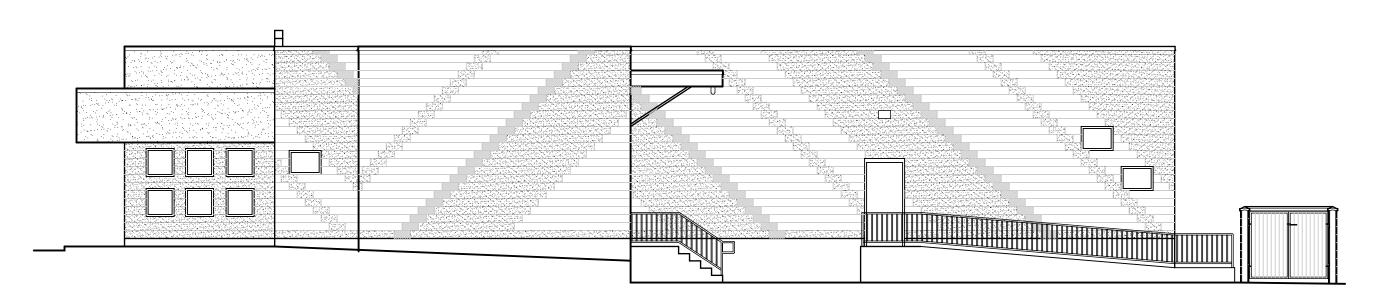
2005-13

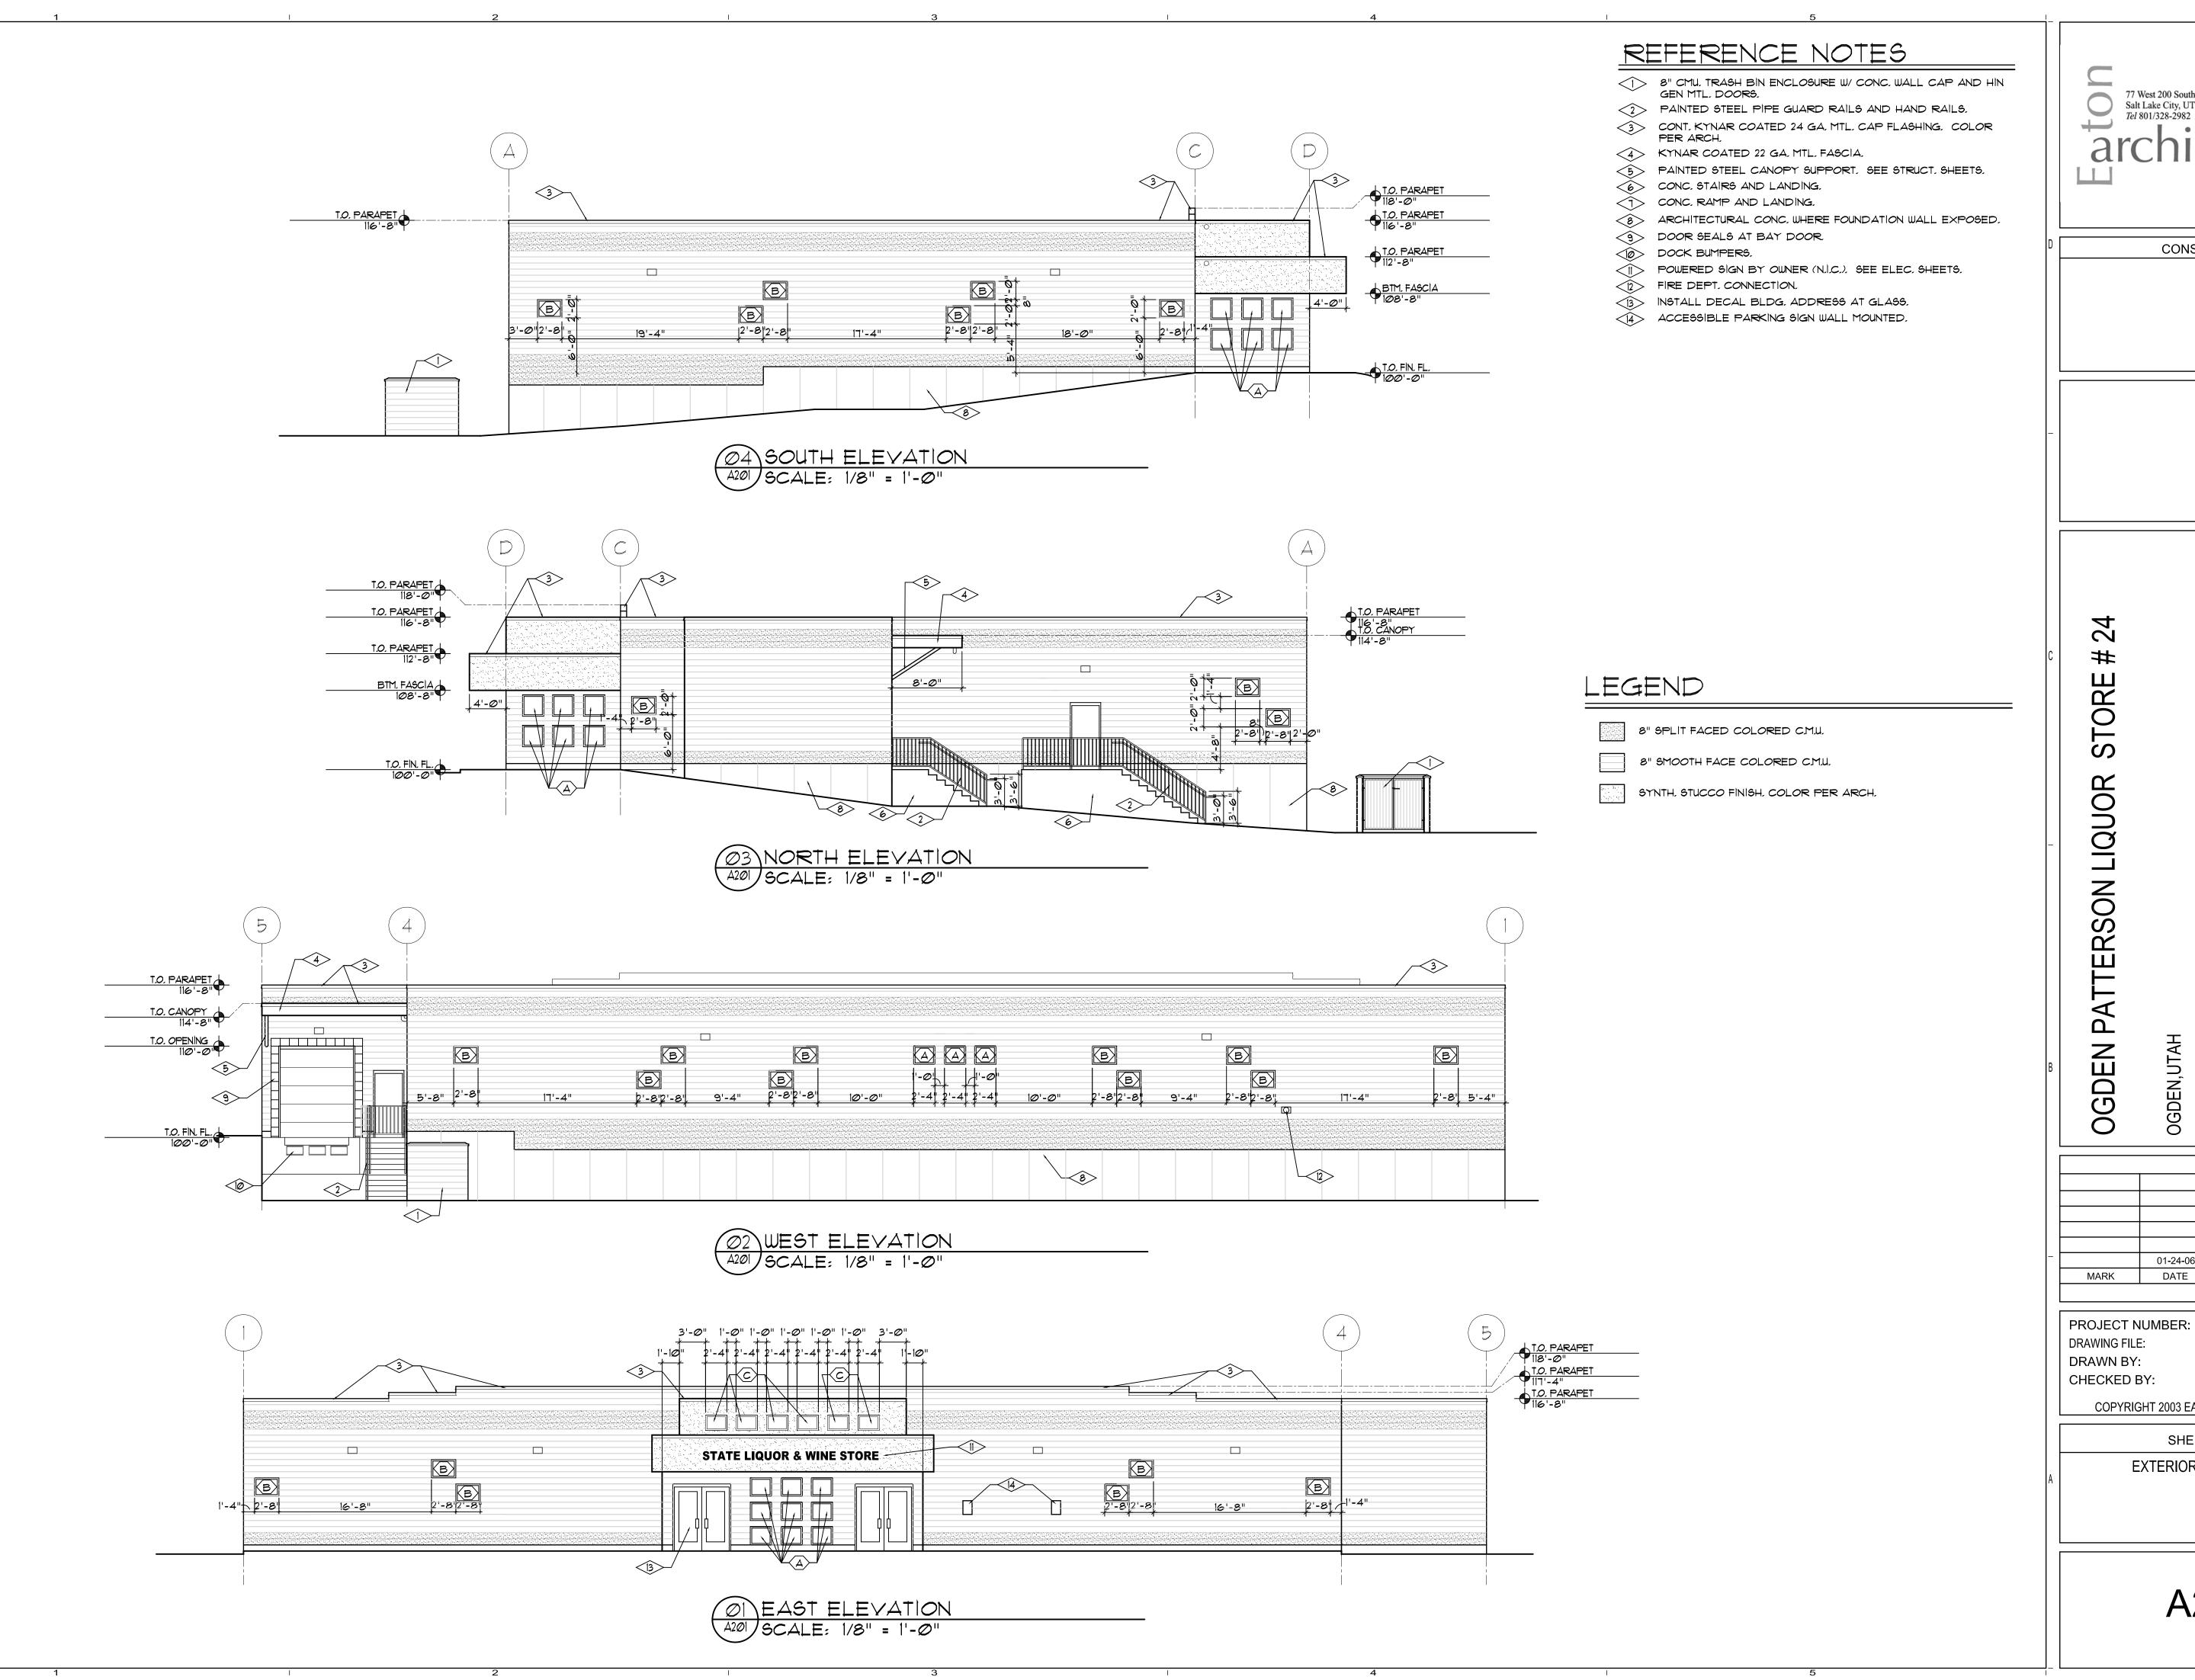SHEET TITLE


EXTERIOR ELEVATIONS



04 SOUTH ELEVATION (ADD, ALT, #2)
A202 SCALE: 1/8" = 1'-0"



03 NORTH ELEVATION (ADD, ALT, #2)
A202 SCALE: 1/8" = 1'-0"

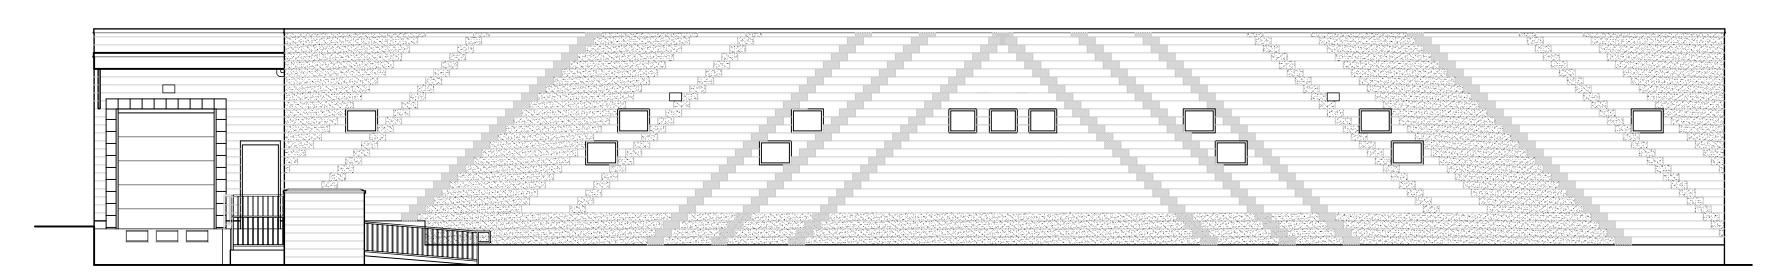

02 WEST ELEVATION (ADD, ALT, #2)
A202 SCALE: 1/8" = 1'-0"




Ø1 EAST ELEVATION (ADD, ALT, #2)

A202 SCALE: 1/8" = 1'-0"

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LIQUOR STORE # 24

LEGEND

8" SPLIT FACED COLORED CMU.

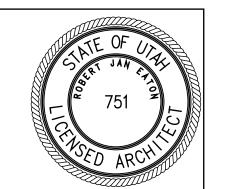8" HONED SURFACE COLORED C.M.U.

8" SMOOTH FACE COLORED CMJ.

SYNTH, STUCCO FINISH, COLOR PER ARCH,

OWNER
UTAH DEPARTMENT OF ALCOHOLIC BEVERAGE CONTROL

2005-13

O1-24-06

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OGDEN PATTERSON

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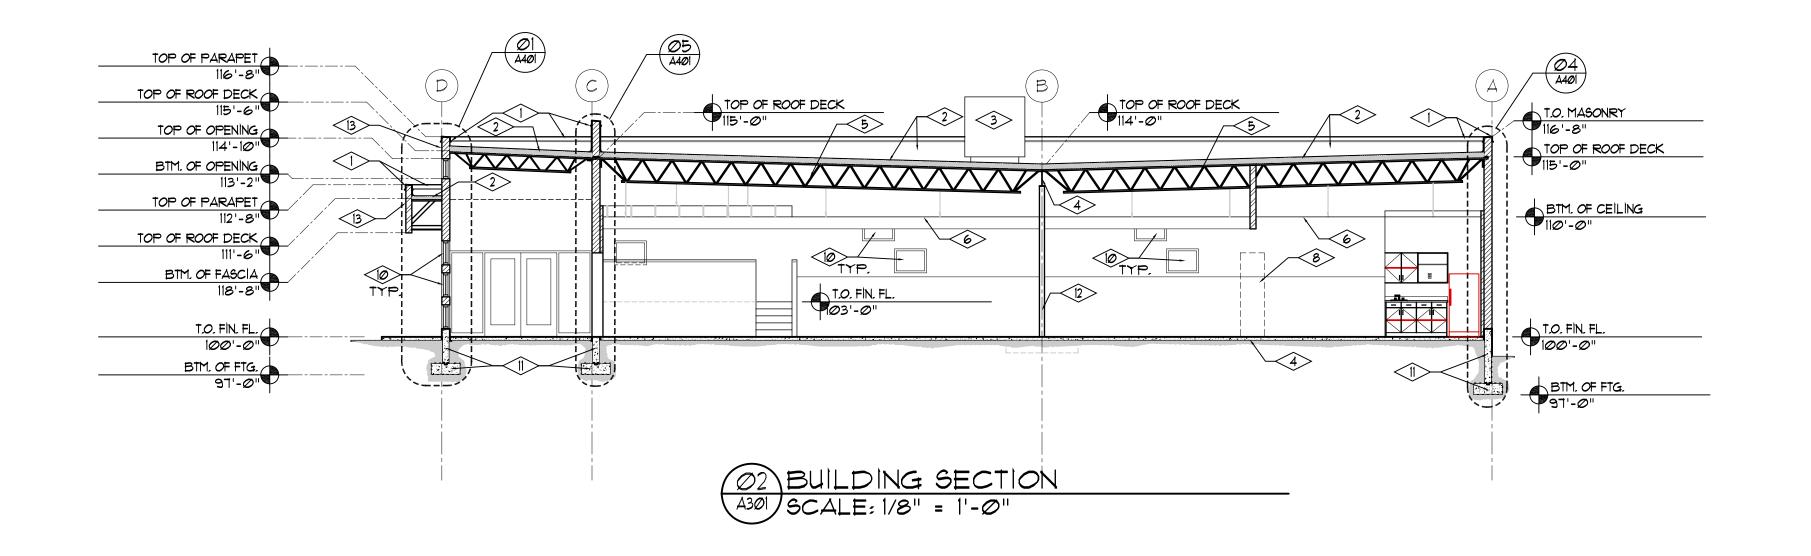
SHEET TITLE

EXTERIOR ELEVATIONS

ADD. ALT. #2

A202

OF



REFERENCE NOTES

- GNT. KYNAR COATED 24 GA. MTL. CAP FLASHING.
- 2> SINGLE-PLY MEMBRANE ROOFING SYSTEM ON 4" RIGID INSUL.
- ROOF TOP MECH, UNIT, W/ CURB, SEE MECH, SHEETS,
- STRUCTURE STEEL BEAM, SEE STRUCTURE SHEET,
- STRUCTURE STEEL ROOF JOIST, SEE STRUCTURE SHEETS.
- 6 SUSPENDED GRID AND PANEL CEILING SYSTEM.
- √1> DOOR AS SCHEDULED.
- (NLC.)
- 9 BUILT-IN COUNTER/CASEWORK
- ANOD, ALUM, WINDOW UNIT AS SCHEDULED,
- CONT. REIN F. CONC. PTG./FDTN. SEE STRUCT. SHEETS...
- PAINTED STRUCT, STEEL COLUMN, SEE STRUCT, SHEETS,
- SYNTH, STUCC, ON EXT, PLYWD, SHEATHING ON MTL, STUD FRAMING,
- 4" CONC. SLAB ON 4" GRANULAR BASE ON SEE STRUCT. SHEETS.

SYMBOL LEGEND

3-5/8" MTL, STUD FRAMED WALL W/5/8" PAINTED GYP, BD, @ EA, SIDE,


W/5/8" PAINTED GYP. BD. @ EA. SIDE.

8" CMU, WALL.

8" CMU, WALL W/1-½" MTL, CHANNEL FURRING W/ RIGID INSUL, AND 5/8" PAINTED GYP, BD, @ INTERIOR SIDE, INSTALL ½" MASONITE WAINSCOT TO 5'-Ø" A.F.F., AT STOCKING/ STORAGE AREA,



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OHOLIC BEVERAGE CONTROL

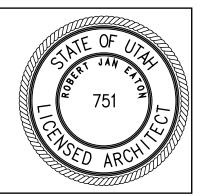2005-13

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STORE

LIQUOR

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OGDEN, UTAH DEPA

PROJECT NUMBER:
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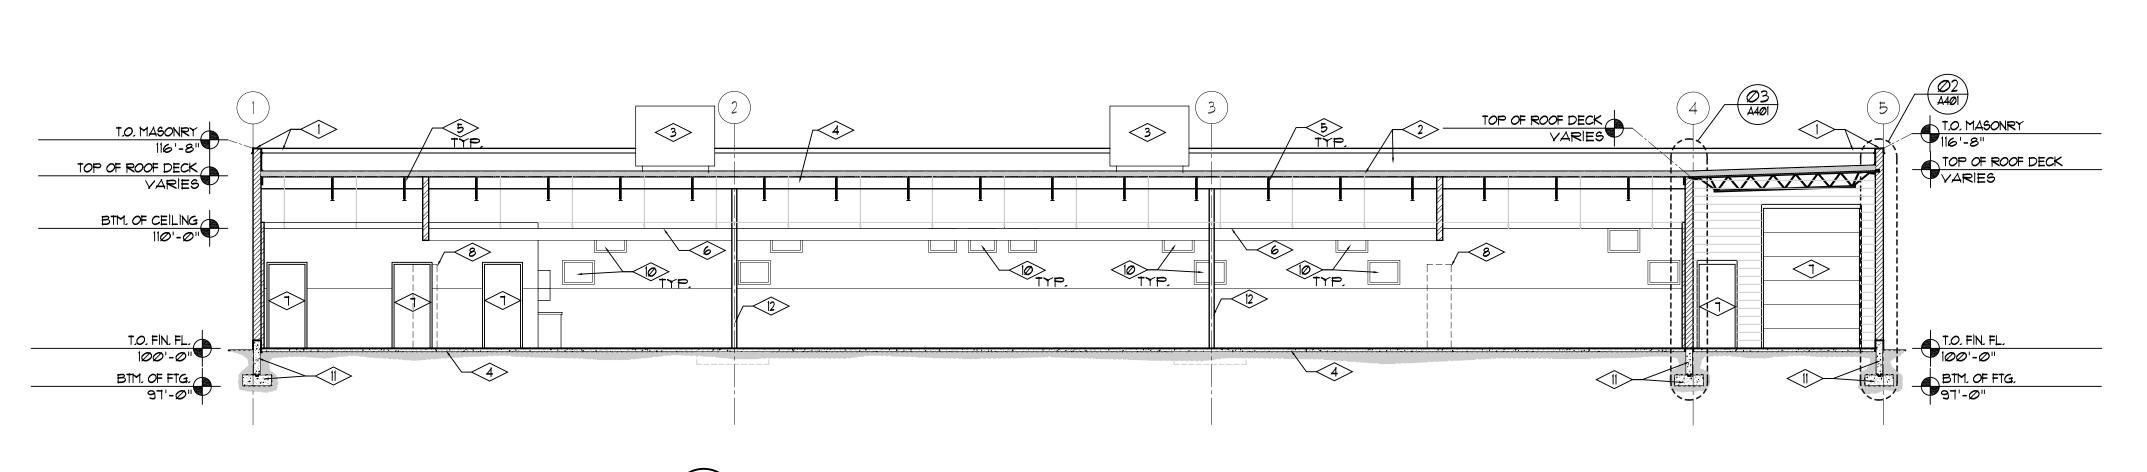
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SHEET TITLE

BUILDING SECTIONS


A301


OF



BUILDING SECTION

A301 SCALE: 1/8" = 1'-0"

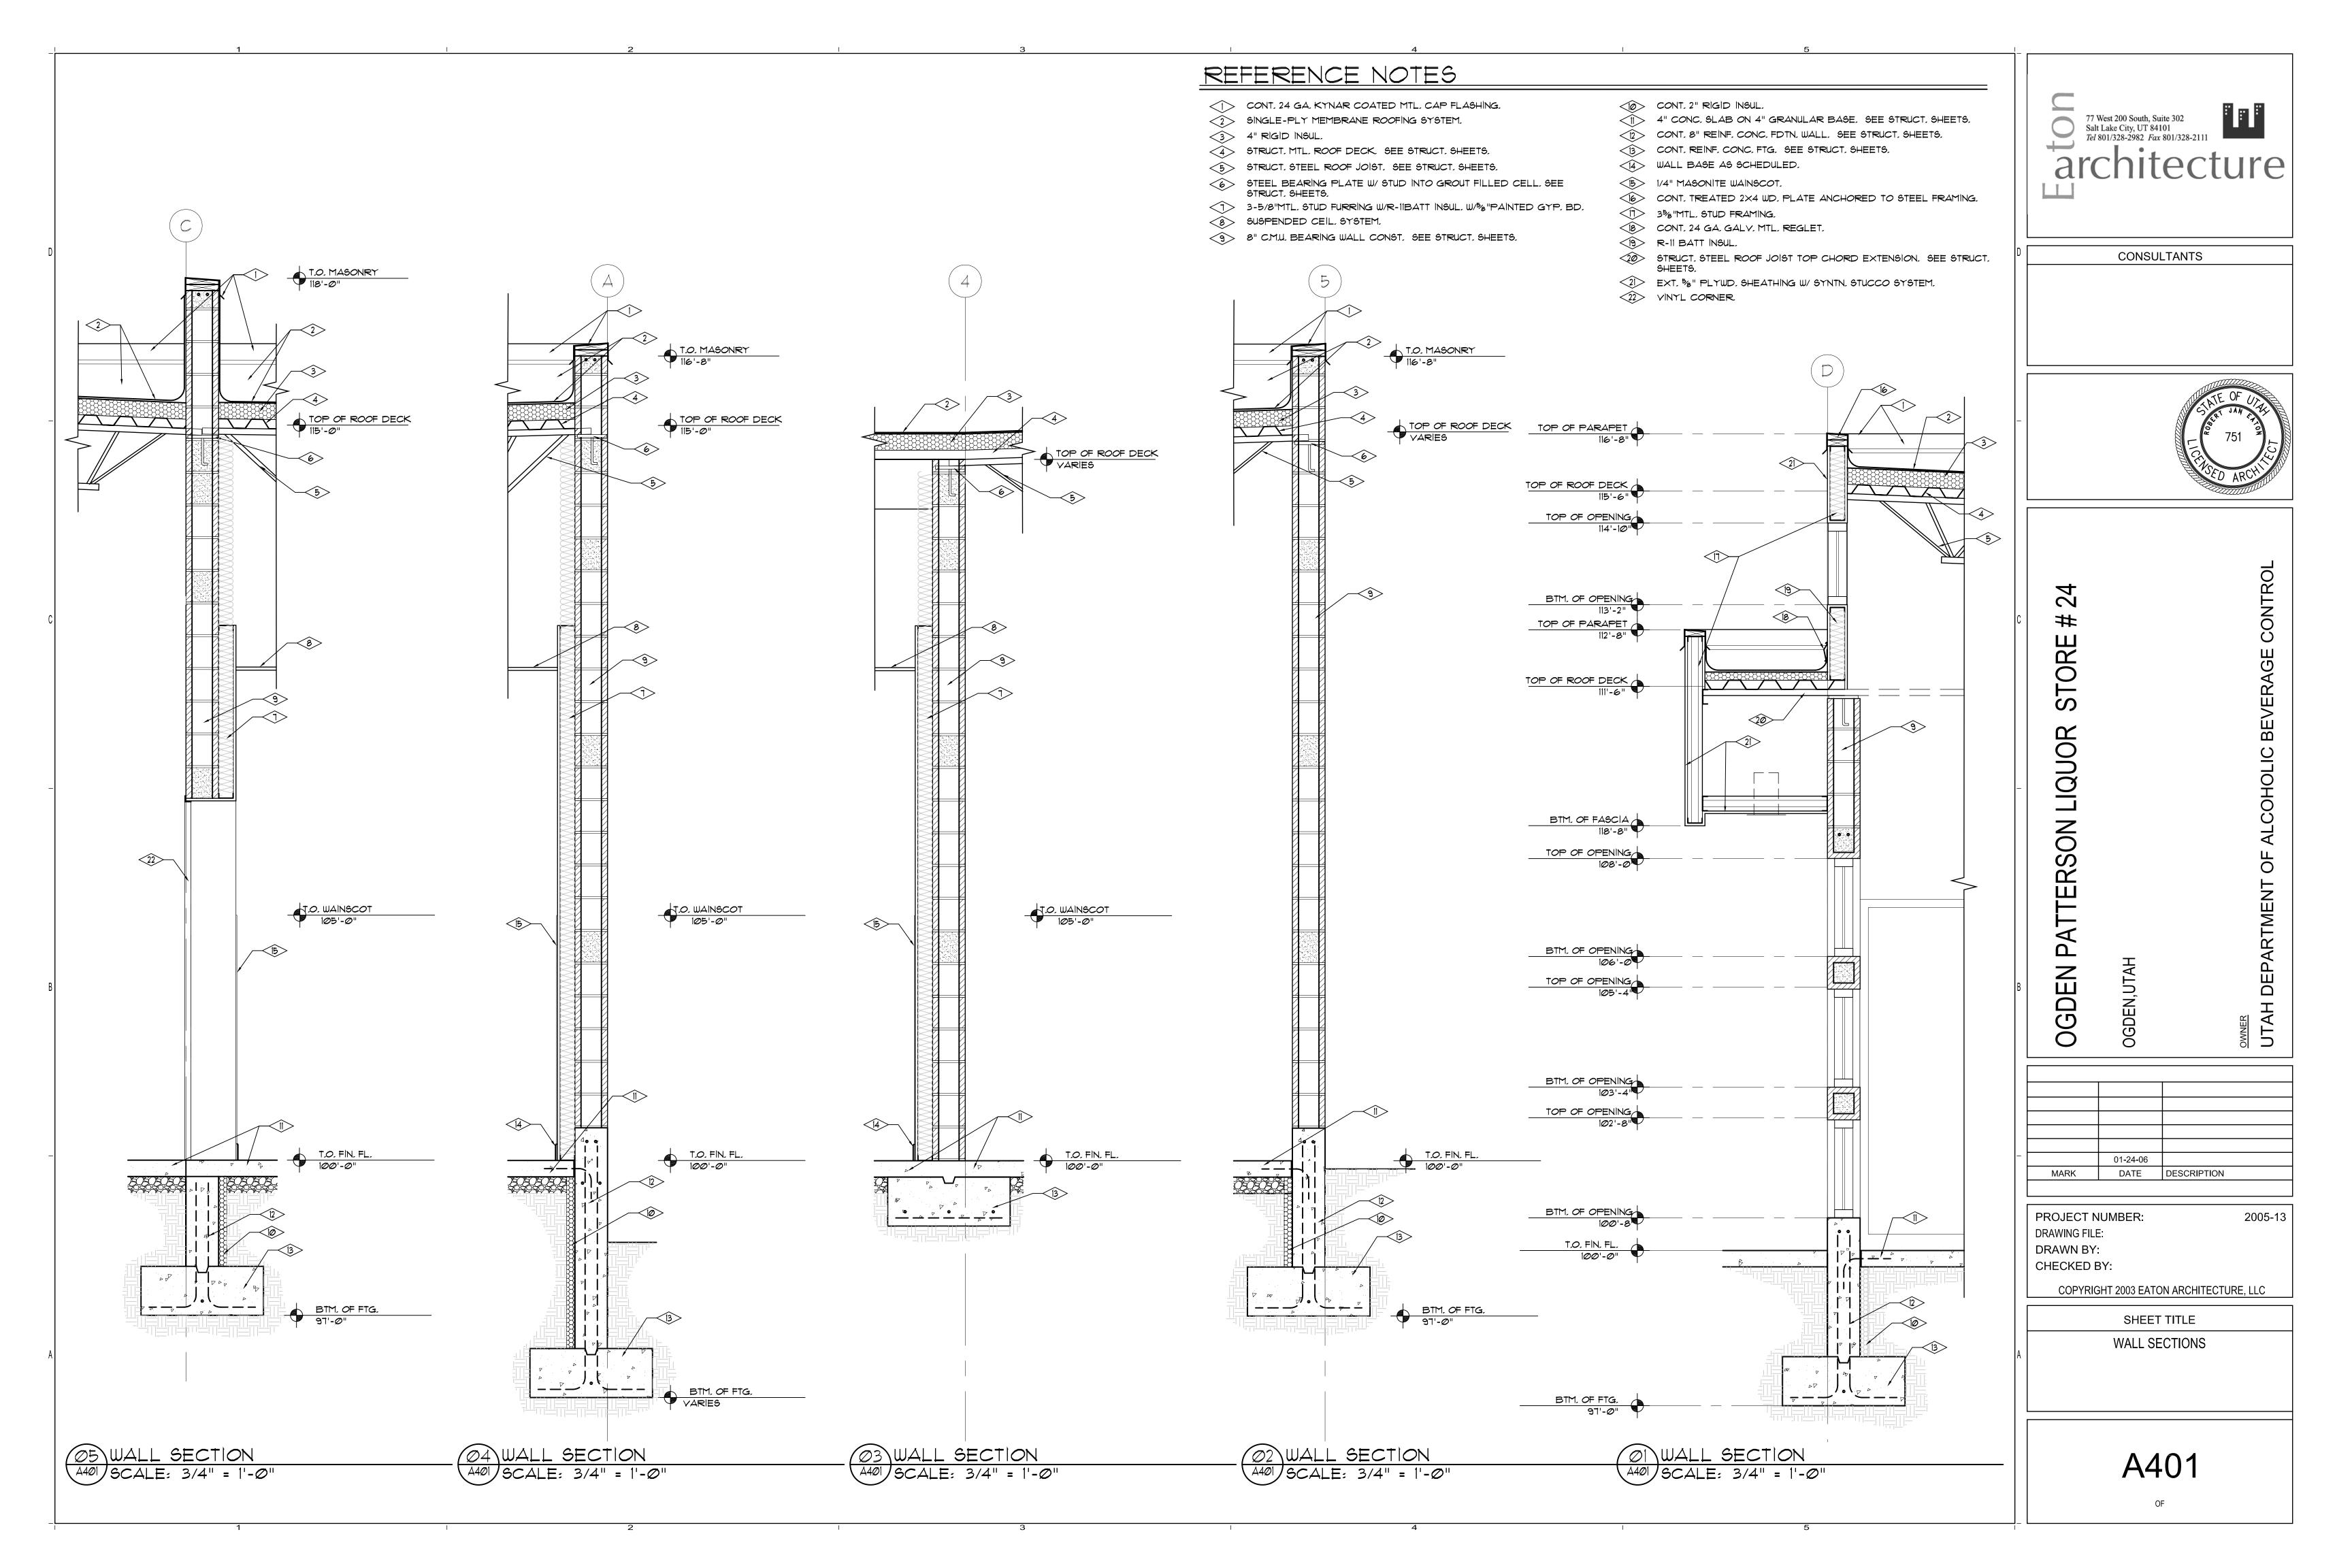


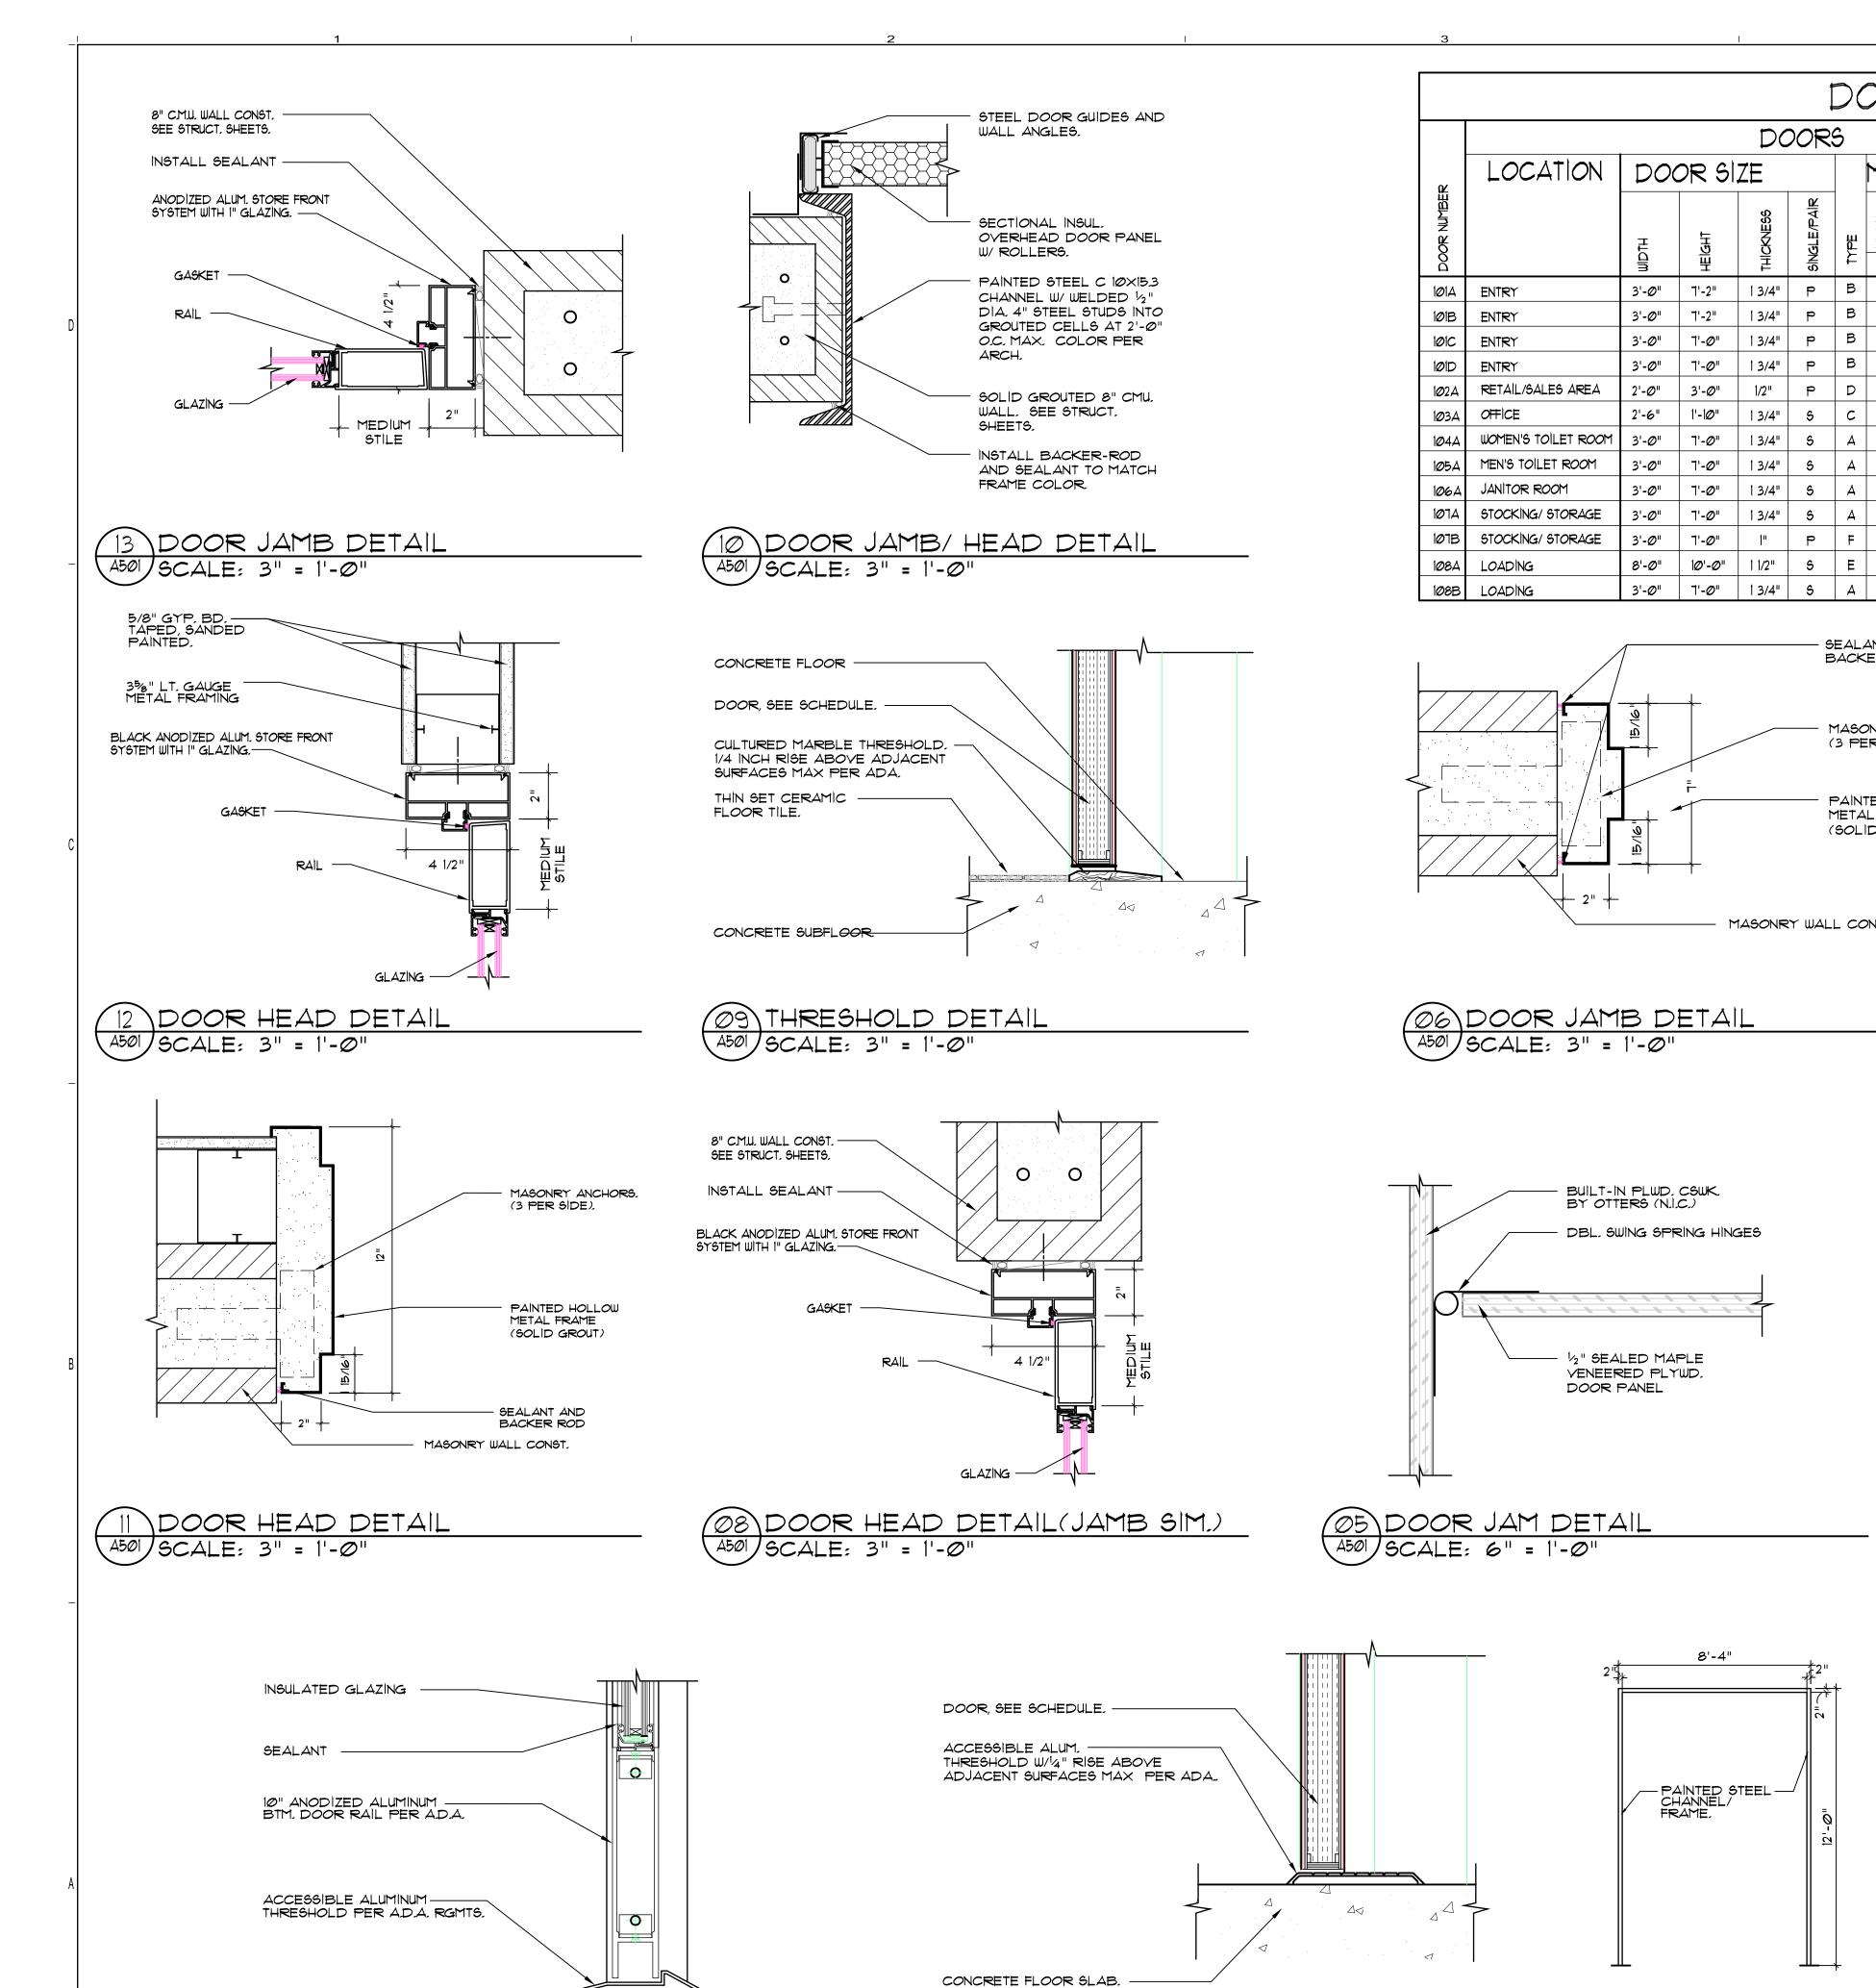



THRESHOLD DETAIL

THRESHOLD DETAIL


SCALE: 3" = 1'-0'

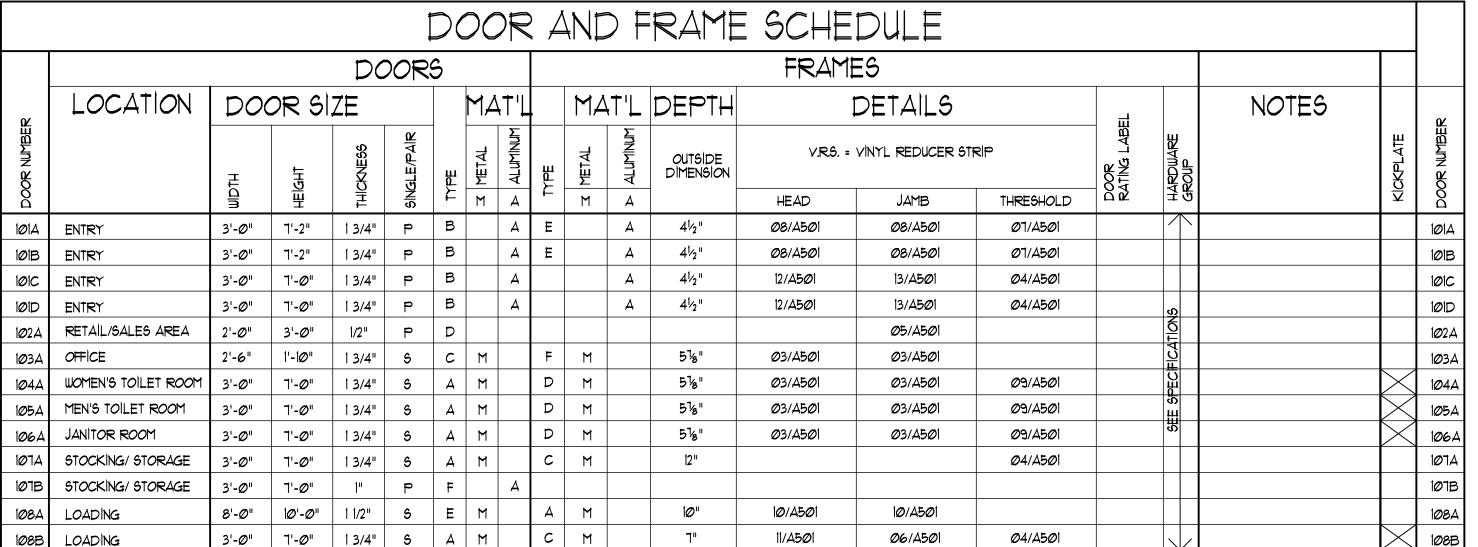


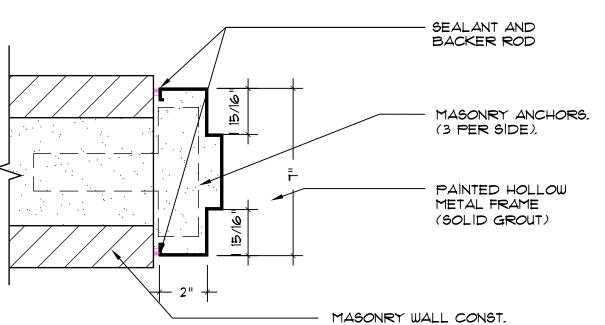

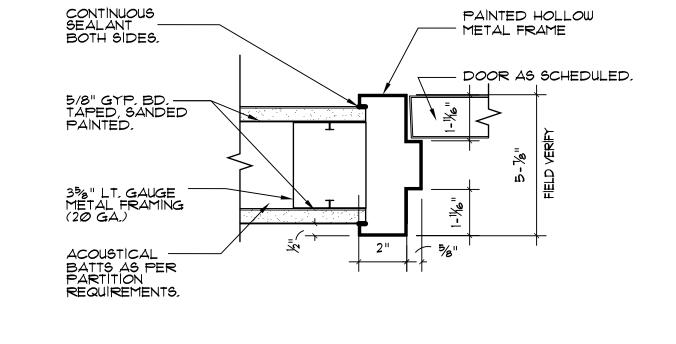




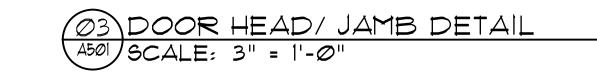

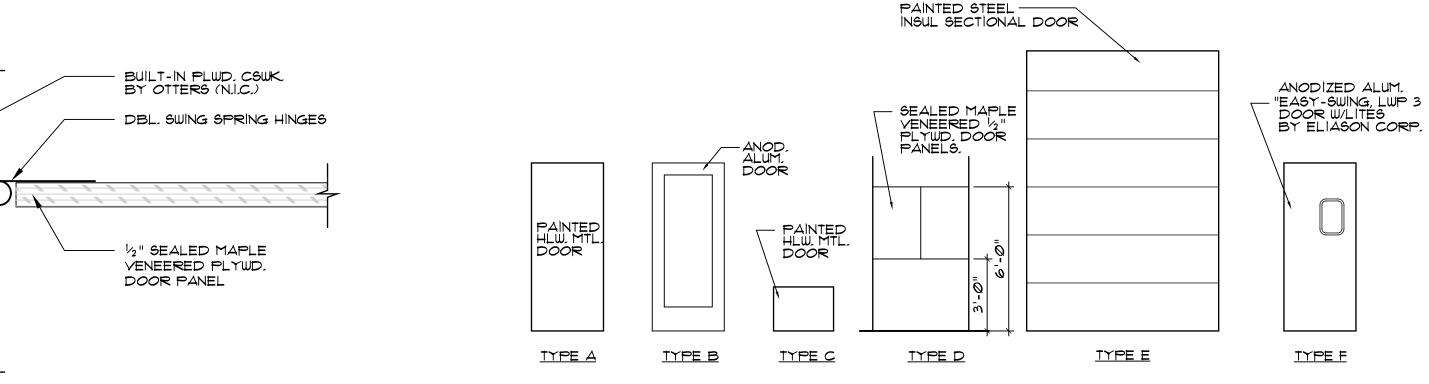




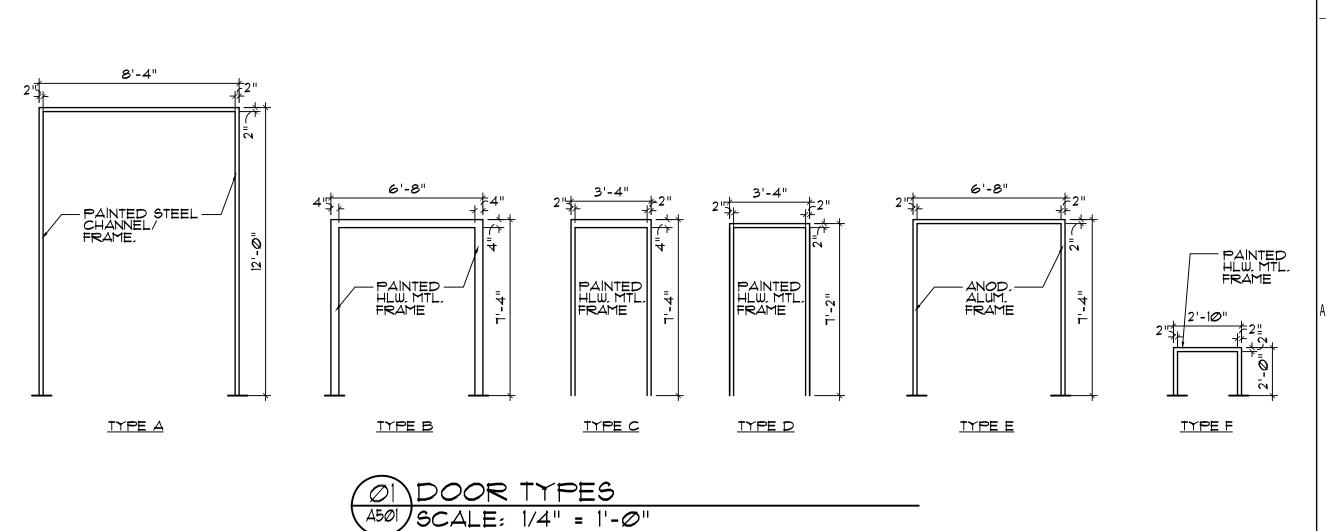




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BEVERAGE CONTROL

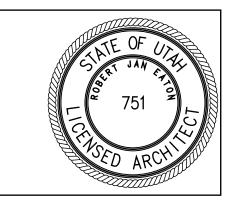N ORE S LIQUOR TERSON OWNER UTAH DEPARTMENT



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GD

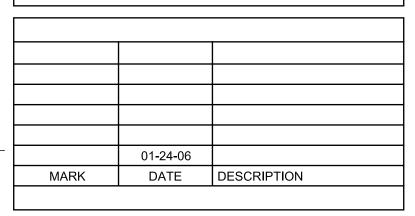PROJECT NUMBER: 2005-13	3
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SHEET TITLE DOOR & FRAME SCHEDULE



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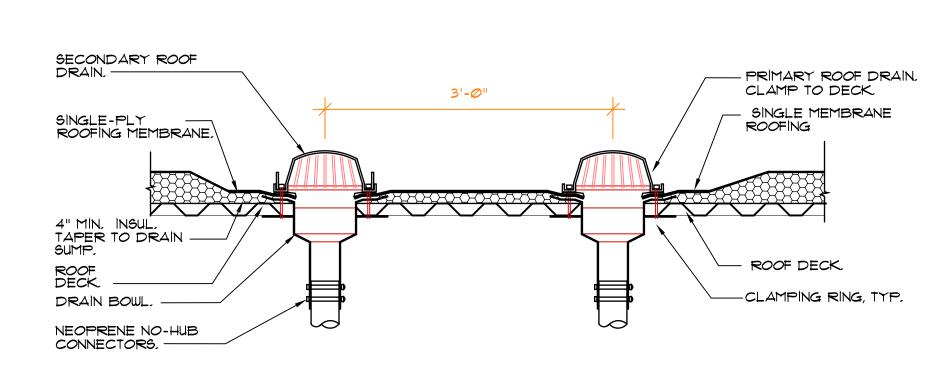
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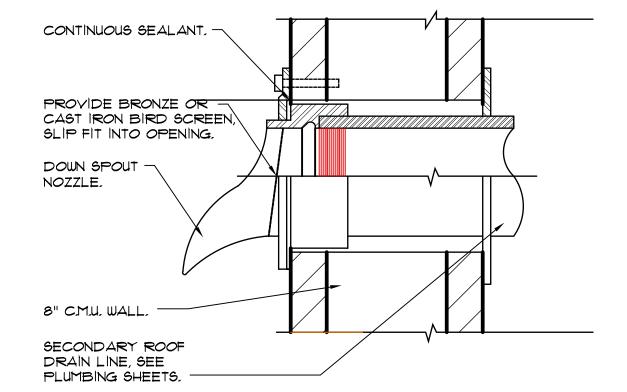
TTERSON


CONTROL




09 ROOF DRAIN DETAIL


AGOI SCALE: 1" = 1'-0"



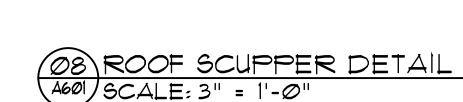


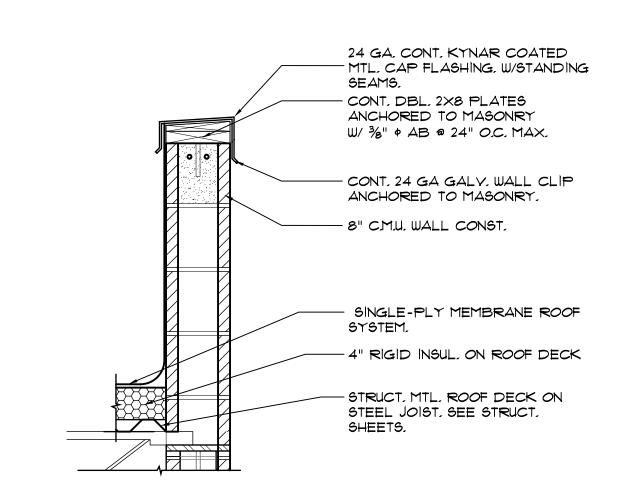



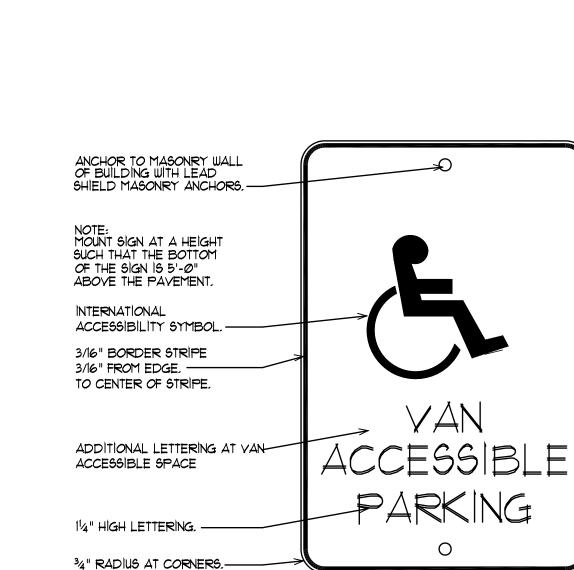



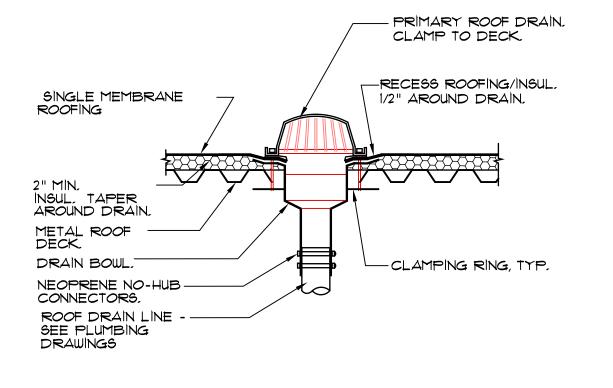

Ø5 ROOF DRAIN DETAIL

A601 SCALE: 1" = 1'-0"


- MOUNDED TOP FINISH

- 4" DIA, (INSIDE DIM.) STANDARD STEEL PIPE GROUTED SOLID AND PAINTED, COLOR


NEW ASPHALT AND ROAD BASE.

CONCRETE FOOTING,

BY ARCH.

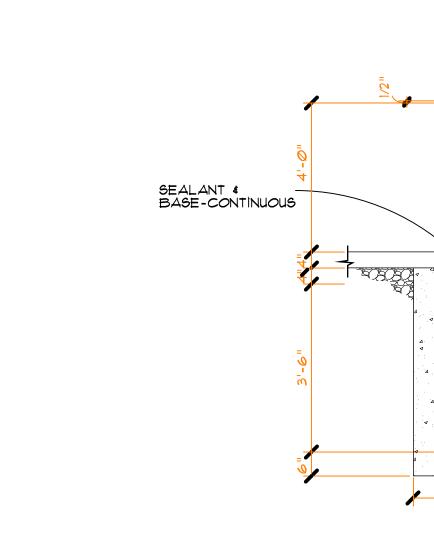


02 PIPE BOLLARD
A601 SCALE: 1/2" = 1'-0"

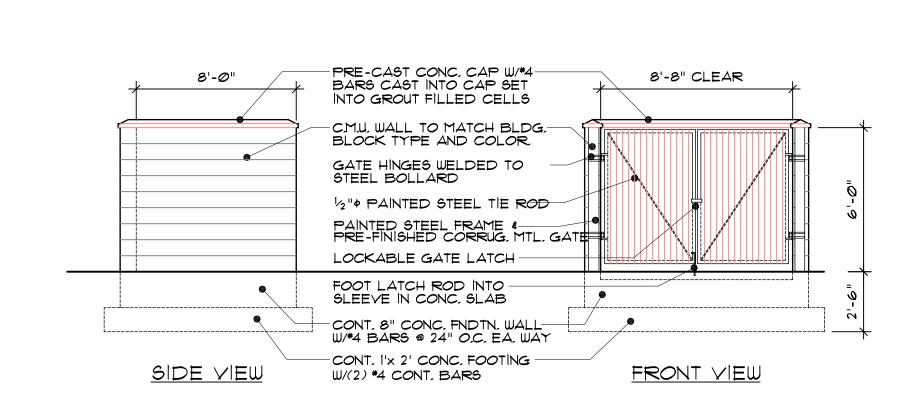

OI TRASH BIN ELEVATIONS

AGOI SCALE: N.T.S.

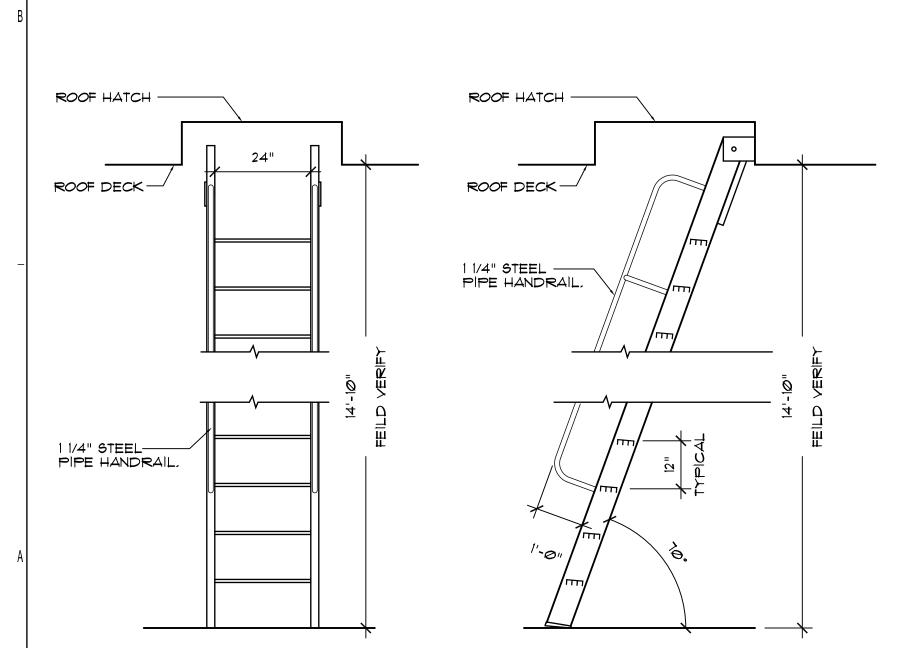

OT ROOF HATCH DETAIL

A601 SCALE: 3/4" = 1'-0"

2'-6"

PAINTED STEEL PIPE

GUARDRAILS PER. OSHA

PRE-MANUF, ROOF HACTH,

SINGLE-PLY MEMBRANE ROOF SYSTEM, WRAP-UP UNDER HATCH CURB FLASHING,

STRUCT, MTL, ROOF DECK.

SEE STRUCT, SHEETS,

STRUCT, STEEL ANGLE.

SEE STRUCT, SHEETS,

PER OSHA ROMTS,

PAINTED STEEL SHIPS LADDER

- 4" RIGID INSUL,

ROMTS, COLOR PER ARCH,

Ø3 SHIPS LADDER DETAIL

A601 SCALE: 1/2" = 1'-0"

OGDEN, UTAH

OHAT

PROJECT NUMBER: 2005-13
DRAWING FILE:
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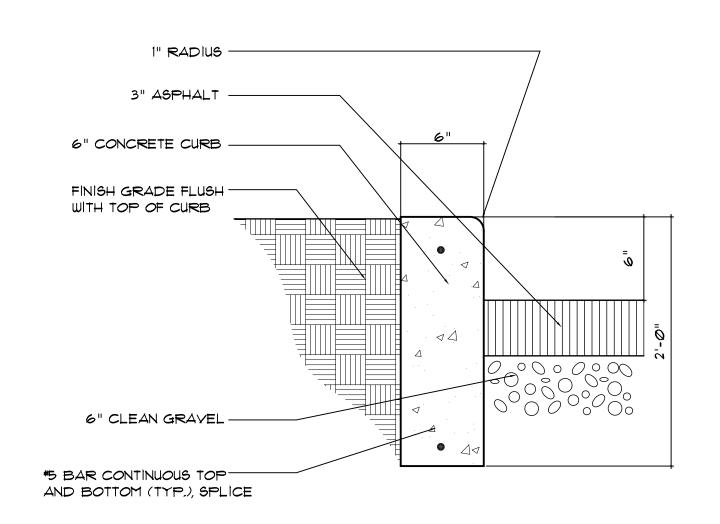
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SHEET TITLE

DETAILS

A601

OF



— 3" ASPH, PAVÍNG - CONC. SLAB ON GRADE


O5 CURB DETAIL

A602 SCALE: NOT TO SCALE

04 NOT USED

03 SIDEWALK DETAIL
A602 SCALE: 1 1/2 " = 1'-0"


02 NOT USED A602 SCALE:

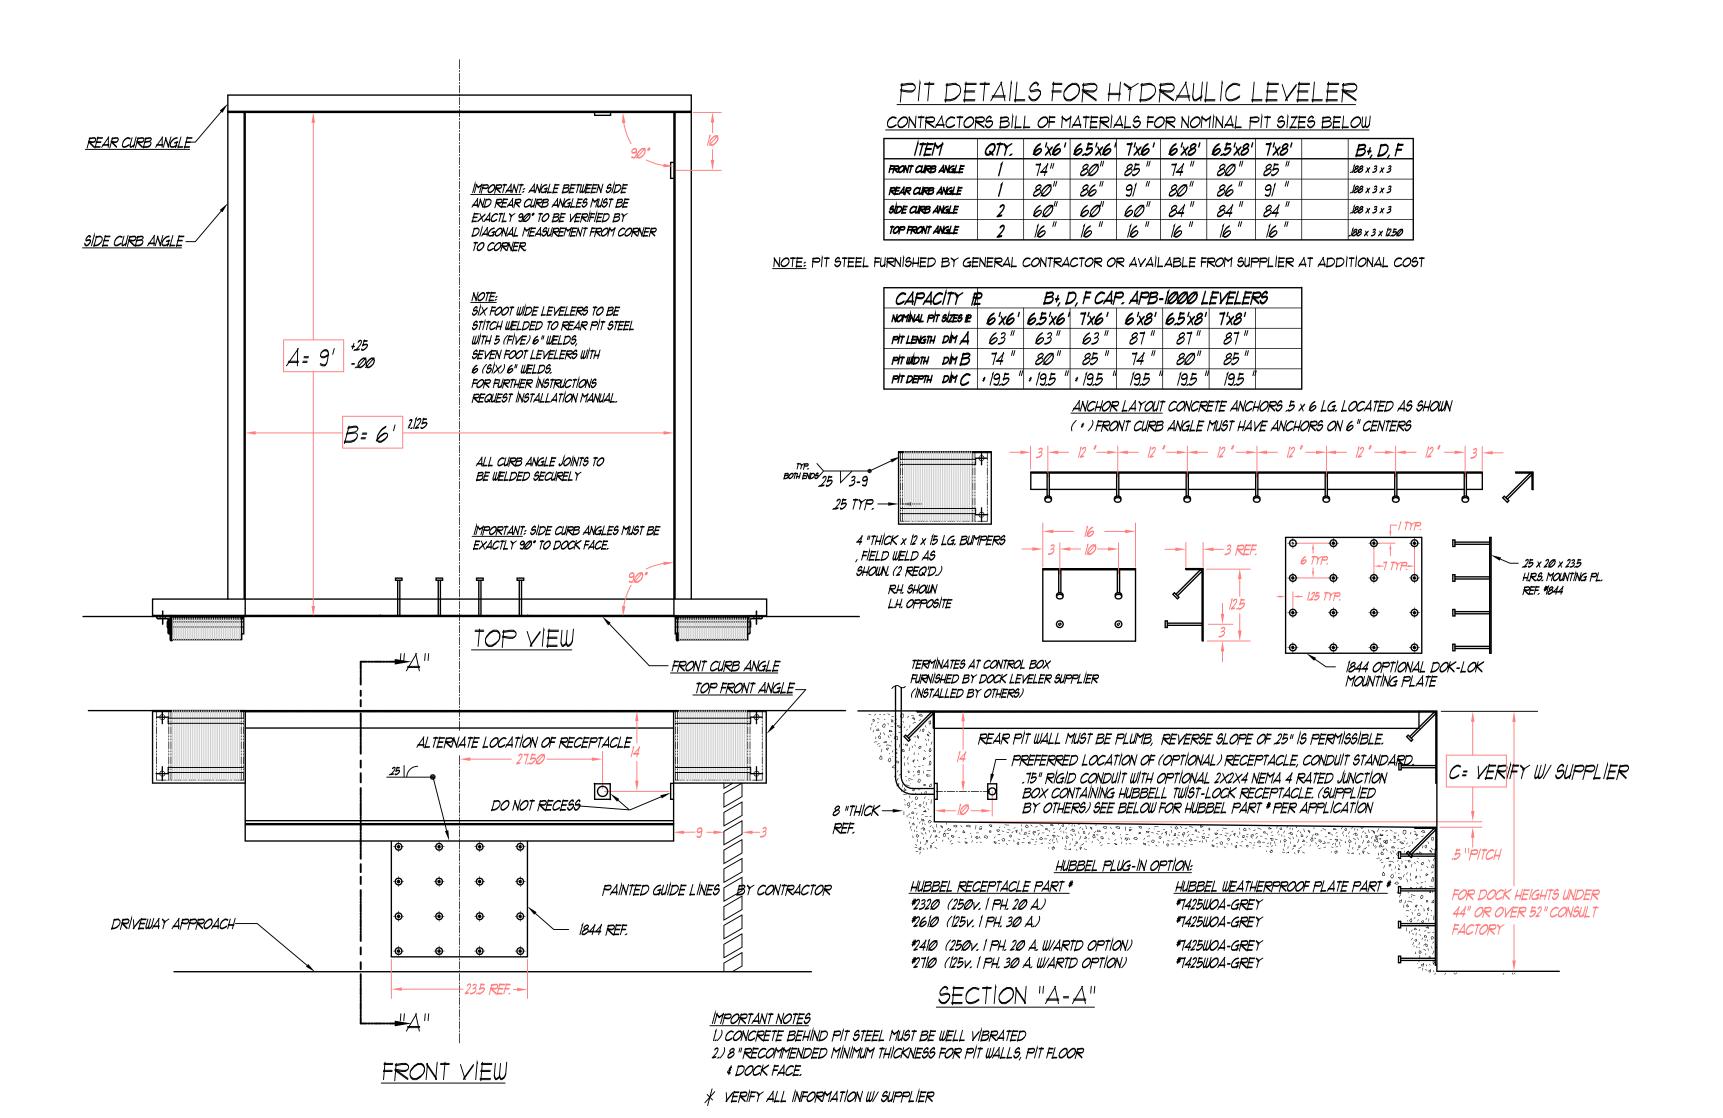

ON DOCK LEVELER DETAILS A602 SCALE: 3/4" = 1'-0"



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S STORE LIQUOR **PATTERSON** OGDEN OWNER UTAH

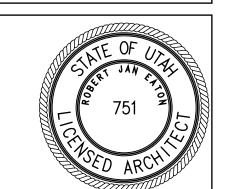DEPARTMENT

	
01-24-06	
DATE	DESCRIPTION

PROJECT NUMBER: 2005-13 DRAWING FILE: DRAWN BY: CHECKED BY: COPYRIGHT 2003 EATON ARCHITECTURE, LLC

> SHEET TITLE **DETAILS**

> > A602

OF

GENERAL STRUCTURAL NOTES:

I. GENERAL:

- A. THE STRUCTURAL DRAWINGS SHOW THE COMPLETED PROJECT. DETAILS, SECTIONS, AND NOTES SHOWN ON THE DRAWINGS SHALL BE TYPICAL AND APPLY TO SIMILAR SITUATIONS
- ELSEWHERE UNLESS NOTED OR SHOWN OTHERWISE. B. REFER TO THE SPECIFICATIONS FOR INFORMATION NOT COVERED BY THESE NOTES OR STRUCTURAL DRAWINGS. WHERE THE STRUCTURAL NOTES, DRAWINGS OR SPECIFICATIONS DISAGREE, THE CONTRACTOR MAY REQUEST A CLARIFICATION. OTHERWISE
- THE MORE STRINGENT REQUIREMENTS SHALL CONTROL. CONTRACTOR SHALL COMPARE ALL DIMENSIONS AND CONDITIONS ON CONTRACT DOCUMENTS AND AT THE SITE. ANY OMISSION OR CONFLICT SHALL BE BROUGHT TO THE ATTENTION OF THE ARCHITECT/ENGINEER. IN CASE OF ANY CONFLICT FOLLOW THE MOST STRINGENT REQUIREMENT AS DIRECTED BY ARCHITECT/ENGINEER.
- D. SEE THE ARCHITECTURAL DRAWINGS FOR DOORS, WINDOWS, NON-BEARING INTERIOR AND EXTERIOR WALLS, RECESSES, DEPRESSIONS, ETC.
- E. THE CONTRACTOR SHALL BE RESPONSIBLE FOR SAFETY AND PROTECTION IN AND AROUND THE JOB SITE AND ADJACENT **PROPERTIES**
- F. CONTRACTOR SHALL PROVIDE ADEQUATE TEMPORARY BRACING FOR ALL PORTIONS OF THE BUILDING UNTIL THE ENTIRE STRUCTURE OF THE BUILDING IS COMPLETE.
- OBSERVATION VISITS TO THE SITE BY STRUCTURAL ENGINEER'S FIELD REPRESENTATIVES SHALL NOT BE CONSTRUED AS
- INSPECTION OR APPROVAL OF CONSTRUCTION. H. ANY ENGINEERING DESIGN PROVIDED BY OTHERS AND SUBMITTED FOR REVIEW SHALL BEAR THE SEAL AND SIGNATURE OF A STRUCTURAL ENGINEER REGISTERED IN UTAH.

II. DESIGN CRITERIA:

- A. BUILDING CODE: 2003 INTERNATIONAL BUILDING CODE (IBC) W/ **AMENDMENTS** B. LOADINGS:
 - 1. ROOF SNOW LOAD = 30 PSF +DRIFTING & w/
- IMPORTANT FACTOR PER IBC BASIC WIND LOAD - 90 MPH ZONE - EXPOSURE C 3. SEISMIC DESIGN CATEGORY: E.

C. FOUNDATION:

- PER SOILS INVESTIGATION REPORT.
- 2. ALL EXTERIOR FOOTINGS ARE TO BE FOUNDED AT NOT LESS THAN 30" BELOW LOWEST ADJACENT FINISH FLOOR OR FINISH GRADE ONTO THE NATIVE SOILS AND/OR ON PROPERLY PLACED AND COMPACTED STRUCTURAL FILL AND BE DESIGNED USING AN ALLOWABLE BEARING CAPACITY OF UP TO 2500 PSF. INTERIOR FOOTINGS ARE TO BE FOUNDED AT NOT LESS THAN 8" BELOW LOWEST ADJACENT FINISH FLOOR OR FINISH GRADE.
- 3. ALL FOOTING EXCAVATIONS ARE TO BE REVIEWED BY A QUALIFIED GEO-TECHNICAL REPRESENTATIVE WHO IS FAMILIAR WITH THE ABOVE REFERENCED SOILS REPORT, TO VERIFY THE SUITABILITY OF THE DESIGN BEARING PRESSURE USED.

III. CONCRETE:

- A. ALL MATERIALS SHALL COMPLY WITH ACI 318 AND ACI 347 PUBLICATIONS AND APPLICABLE ASTM PUBLICATIONS.
- B. CONCRETE MATERIAL PROPERTIES: 28-DAY COMPRESSIVE STRENGTHS ARE TO BE 3000 PSI TYPICAL UNLESS NOTED OTHERWISE. DESIGN BASED ON 2500 PSI. CONCRETE SLAB ON GRADE TO BE 4000 PSI.
- C. CAST IN PLACE CONCRETE:
 - 1. SPACING OF CONSTRUCTION JOINTS OR CONTROL JOINTS IN WALLS EXPOSED TO VIEW SHALL NOT EXCEED 40 FEET UNLESS SPECIFICALLY NOTED OTHERWISE ON THE
 - DRAWINGS. 2. PROVIDE A 3/4" CHAMFER ON ALL EXPOSED CORNERS OF CONCRETE UNLESS NOTED OTHERWISE. 3. PROVIDE CLASS B LAP SPLICES FOR ALL REINFORCING
 - UNLESS NOTED OTHERWISE. 4. PROVIDE ISOLATION JOINTS AROUND ALL COLUMNS AT ALL EXPOSED SLAB ON GRADE AREAS.

IV. REINFORCING STEEL:

- A. ALL BARS #4 AND LARGER TO BE ASTM A 615, GRADE 60. ALL #2 AND #3 BARS TO BE ASTM A 615, GRADE 40. DETAILED, FABRICATED AND ERECTED IN ACCORDANCE WITH ACI-318, LATEST ADOPTION.
- B. ALL REINFORCING STEEL SHALL BE BENT, DETAILED AND CHAIRED AS PER "ACI MANUAL OF STANDARD PRACTICE FOR DETAILING REINFORCING CONCRETE STRUCTURES".
- WELDED WIRE FABRIC TO BE IN ACCORDANCE WITH ASTM A 185. ALL BARS INDICATED ON THE PLANS TO BE WELDED SHALL CONFORM TO ASTM A706 (GRADE 60).
- CONCRETE COVER REQUIREMENTS FOR DEFORMED BAR REINFORCING STEEL SHALL COMPLY WITH ACI 318, "BUILDING CODE REQUIREMENTS FOR REINFORCING CONCRETE'

1. CAST-IN-PLACE CONCRETE:

- a) CONCRETE CAST AGAINST AND PERMANENTLY EXPOSED TO EARTH:
- b) FORMED CONCRETE EXPOSED TO EARTH OR WEATHER:
- #6 BARS AND LARGER: #5 BARS AND SMALLER: 1-1/2" c) CONCRETE NOT EXPOSED TO WEATHER OR IN CONTACT WITH GROUND:
- SLABS, WALLS JOISTS: #11 BARS OR SMALLER: BEAMS, COLUMNS: PRIMARY REINFORCING, TIES, STIRRUPS, SPIRALS: 1-1/2"
- F. DETAILING: SUBMIT PLACING DRAWINGS PER ACI DETAILING MANUAL, ACI SP-66. FABRICATE ONLY AFTER REVIEW AND APPROVAL. REINFORCING BARS SHALL NOT BE WELDED UNLESS SPECIFICALLY SHOWN ON DRAWINGS.
- 1. LAP SPLICE LENGTHS SHALL BE AS FOLLOWS: 30 BAR DIAMETER FOR #3 AND #4 BARS 40 BAR DIAMETER FOR #5 THROUGH #8 BARS DO NOT SPLICE STIRRUPS AND TIES DO NOT SPLICE VERTICAL BARS IN RETAINING WALLS UNLESS SPECIFICALLY SHOWN.

V. MASONRY: A. GENERAL:

- 1. LIGHTWEIGHT HOLLOW CONCRETE MASONRY UNIT TO BE ASTM C 90, GRADE N-1 AND HAVE A MINIMUM UNIT STRENGTH OF 2800 PSI AND I'M OF 2000 PSI. MORTAR TO BE TYPE "S". GROUT FILL TO BE 2000 PSI AT 28
- 2. MASONRY DESIGN IS BASED ON VALUES WITH LEVEL 2
- INSPECTION PER ACI 530-99. 3. SEE CONCRETE FOR REQUIREMENTS FOR REINFORCING.

- B. MASONRY REINFORCING:
 - MINIMUM REINFORCING OF CONCRETE MASONRY UNIT WALLS:
 - ALL MASONRY WALLS SHALL BE REINFORCING AS SCHEDULED. 2. C.M.U. WALLS ARE TO HAVE #5 VERTICALS AT ALL
 - CORNERS, ENDS, JAMBS, INTERSECTIONS AND BOTH SIDES OF CONTROL JOINTS, TYPICAL UNLESS NOTED OTHERWISE. ADDITIONAL VERTICAL REINFORCING SHOWN ON PLAN IS IN LIEU OF TYPICAL REINFORCING. PLACE ONE BAR PER CELL IN SOLID GROUT. EXTEND BARS A MINIMUM OF 30
 - BAR DIAMETERS BEYOND THE ROOF LEVEL ABOVE. BUILDING WALLS ARE TO HAVE 2 #5 BARS CONTINUOUS IN A MINIMUM 8" DEEP BOND BEAM AT ALL ROOF LEVELS UNLESS NOTED OTHERWISE.
 - BUILDING WALLS ARE TO HAVE 1 #5 BAR CONTINUOUS IN A MINIMUM 8" DEEP BOND BEAM AT THE TOP OF ALL PARAPETS UNLESS NOTED OTHERWISE. PROVIDE A MINIMUM OF 2 #5 BARS X (THE WIDTH OF THE OPENING PLUS 4'-0") IN A MINIMUM 8" DEEP BOND BEAM

BELOW ALL WINDOW AND MECHANICAL OPENINGS UNLESS

NOTED OTHERWISE. C. MASONRY LINTELS:

- 1. ALL REINFORCING IS TO EXTEND A MINIMUM OF 2'-0" BEYOND THE JAMB AND TO BE GROUTED SOLID FOR THE ENTIRE DEPTH INDICATED.
- ALL CONCRETE MASONRY UNITS USED IN THE LENGTH ARE TO BE "OPEN-END" TYPE, TO INSURE FULLY GROUTED HEAD JOINTS.
- ALL LINTELS ARE TO BE PROPERLY SHORED FOR THEIR WEIGHT PLUS ANY CONSTRUCTION LOADS AND LATERALLY BRACED TO PREVENT ANY LATERAL MOVEMENT FOR A MINIMUM OF 7 DAYS AFTER GROUTING, UNLESS NOTED OTHERWISE.

D. MASONRY GROUTING PROCEDURES:

- GROUTED MASONRY SHALL BE CONSTRUCTED IN SUCH A MANNER THAT ALL ELEMENTS OF THE MASONRY ACT TOGETHER AS A STRUCTURAL ELEMENT.
- PRIOR TO GROUTING, THE GROUT SPACE SHALL BE CLEANED SO THAT ALL SPACES TO BE FILLED WITH GROUT DO NOT CONTAIN MORTAR PROJECTIONS GREATER THAN 1/2", MORTAR DROPPINGS OR OTHER FOREIGN MATERIAL.
- GROUT MATERIALS AND WATER CONTENT SHALL BE CONTROLLED TO PROVIDE ADEQUATE FLUIDITY FOR PLACEMENT, WITHOUT SEGREGATION OF THE CONSTITUENTS AND SHALL BE MIXED THOROUGHLY. SEGREGATION OF THE GROUT MATERIALS AND DAMAGE TO THE MASONRY SHALL BE AVOIDED DURING THE GROUTING PROCESS.
- 4. THE GROUTING OF ANY SECTION OF WALL SHALL BE COMPLETED IN ONE DAY WITH NO INTERRUPTIONS GREATER
- THAN ONE HOUR. BETWEEN GROUT POURS, A HORIZONTAL CONSTRUCTION JOINT SHALL BE FORMED BY STOPPING ALL WYTHES AT THE SAME ELEVATION AND WITH THE GROUT STOPPING A MINIMUM OF 1 1/2 INCHES BELOW A MORTAR JOINT, EXCEPT AT THE TOP OF THE WALL. WHERE BOND BEAMS OCCUR, STOP GROUT POUR A MINIMUM OF 1/2 INCH BELOW THE TOP OF THE MASONRY.
- ALL CELLS AND SPACES CONTAINING REINFORCING BARS SHALL BE FILLED WITH GROUT. GROUT SHALL BE PLACED SO THAT ALL SPACES TO BE GROUTED DO NOT CONTAIN
- GROUT SHALL BE CONSOLIDATED BY MECHANICAL VIBRATION DURING PLACING BEFORE LOSS OF PLASTICITY IN A MANNER TO FILL THE GROUT SPACE. GROUT POURS GREATER THAN 12 INCHES SHALL BE RECONSOLIDATED BY MECHANICAL VIBRATION TO MINIMIZE VOIDS DUE TO WATER LOSS. GROUT POURS 12 INCHES OR LESS IN
- HEIGHT SHALL BE MECHANICALLY VIBRATED, OR PUDDLED. WHERE GROUT POURS EXCEED 5 FEET, CLEANOUTS SHALL BE PROVIDED IN THE BOTTOM COURSE AT EVERY VERTICAL BAR LOCATION BUT SHALL NOT BE SPACED MORE THAN 32 INCHES ON CENTER FOR SOLID GROUTED MASONRY. GROUT SHALL BE PLACED IN A CONTINUOUS POUR NOT TO EXCEED 16 FEET IN HEIGHT, AND IN GROUT LIFTS NOT TO EXCEED 6 FEET.
- REINFORCING SHALL BE CONTINUOUS THE FULL HEIGHT OF THE GROUT POUR PLUS ANY REQUIRED LAP ABOVE. REINFORCEMENT SHALL BE SECURED AGAINST DISPLACE MENT PRIOR TO GROUTING BY WIRE POSITIONERS OR OTHER SUITABLE DEVICES AT INTERVALS NOT TO EXCEED 200 BAR DIAMETERS NOR 10 FEET.
- 10. TOLERANCE FOR THE PLACEMENT OF STEEL IN WALLS AND FLEXURAL ELEMENTS SHALL BE PLUS OR MINUS 1/2 INCH FOR "D" EQUAL TO 8 INCHES OR LESS, PLUS OR MINUS ONE INCH FOR "D" EQUAL TO 24 INCHES OR LESS BUT GREATER THAN 8 INCHES, AND PLUS OR MINUS 1 1/4 INCH FOR "D" GREATER THAN 24 INCHES.

VI. STRUCTURAL AND MISCELLANEOUS STEEL:

A. MATERIAL PROPERTIES:


- ALL SHAPES, PLATES, ANGLES, AND CHANNELS TO BE ASTM A-36 UNLESS NOTED OTHERWISE.
- ALL WF SHAPES WEIGHING 84 POUNDS PER LINEAR FOOT OR LESS TO BE ASTM A 572, GRADE 50. ALL WF SHAPES WEIGHING MORE THAN 84 POUNDS PER LINEAR FOOT TO BE ASTM A 572, GRADE 36.
- SQUARE OR RECTANGULAR TUBES TO BE ASTM A 500, GRADE B, Fy = 46 KSI.
- ALL STEEL TO BE DETAILED, FABRICATED AND ERECTED IN ACCORDANCE WITH A.I.S.C. SPECIFICATIONS, LATEST ADOPTION.

B. WELDING:

- 1. FOR STRUCTURAL STEEL TO BE IN ACCORDANCE WITH A.W.S. REQUIREMENTS FOR E70XX ELECTRODES. E60XX MAY BE USED FOR WELDING STEEL FLOOR AND ROOF DECKS.
- MINIMUM WELDS: ALL INTERSECTING STEEL SHAPES THAT ARE NOT BOLTED SHALL BE CONNECTED BY A FILLET WELD ALL AROUND, UNLESS NOTED OTHERWISE. FILLET WELD SIZES THAT ARE NOT SHOWN SHALL BE 1/16" LESS THAN THE THINNEST OF THE CONNECTED PARTS FOR THICKNESS 1/4" AND LARGER. FILLET WELDS ON PLATES LESS THAN 1/4" SHALL BE OF THE SAME SIZE AS THE THINNEST OF THE CONNECTED PART.


C. BOLTS:

- 1. ALL BOLTS TO BE 3/4" DIAMETER ASTM A 325-N UNLESS NOTED OTHERWISE. A325N BOLTS SHALL BE USED IN CONNECTIONS FOR SIMPLE SPAN FRAMING AND BEAMS TO BEARING PLATE CONNECTIONS. TIGHTEN BOLTS TO SNUG TIGHT CONDITION
- BOLTS, NUTS AND WASHERS SHALL NOT BE REUSED. ANCHOR BOLTS SHALL BE ASTM A 307 OR A 36.
- EXPANSION BOLTS ARE 3/4" DIAMETER RAMSET "DYNABOLTS" INSTALLED IN ACCORDANCE WITH ICBO #1372. MINIMUM EMBEDMENT TO BE 3 1/2" IN CONCRETE AND 5" IN SOLID GROUTED MASONRY. ALL CONCRETE OR MASONRY SHALL BE AT ITS SPECIFIED DESIGN STRENGTH AT THE TIME OF INSTALLATION.
- VII. SPECIAL INSPECTION: SPECIAL INSPECTION IS REQUIRED IN ACCORDANCE WITH U.B.C. SECTION 1701.
 - A. ALL CONCRETE MASONRY UNITS AND REINFORCING. FIELD WELDING.

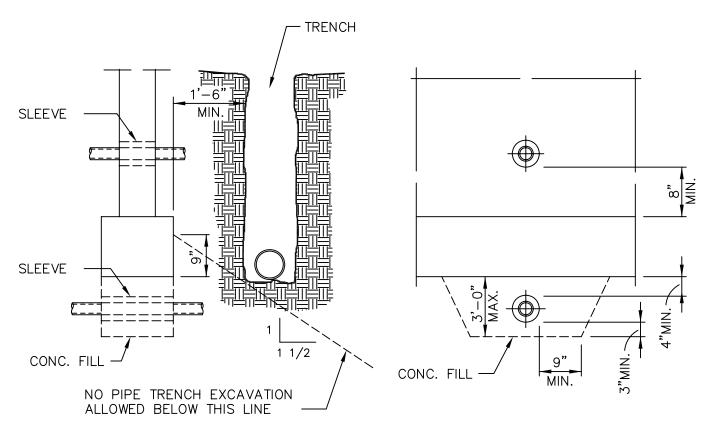


NOTE: CONCRETE FILL TO BE THE SAME WIDTH AS FOOTING & FULL WIDTH OF PIPE TRENCH. PIPE TO CLEAR SLEEVE BY 1/2" ALL AROUND


PIPES AT CONCRETE FOOTING

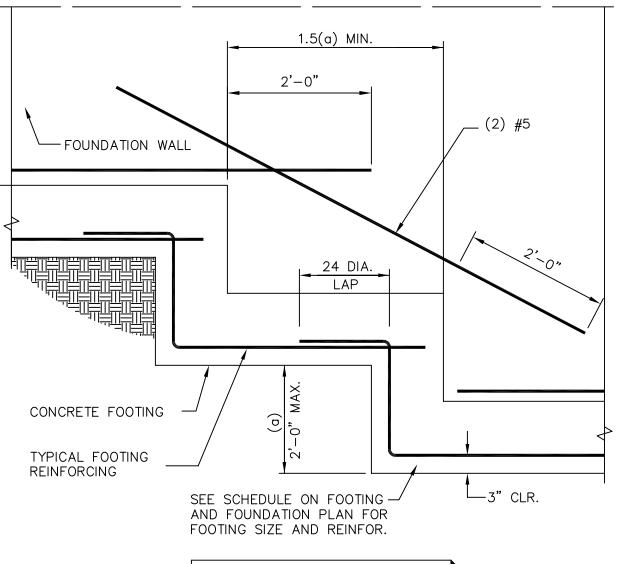

NOTE: REINFORCING MAY BE CONTINUOUS

YPICAL STEPPED FOOTING

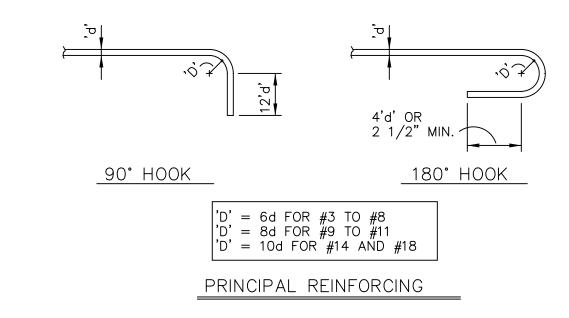

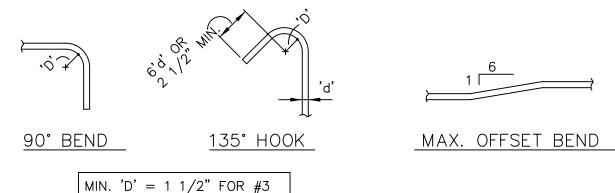



NOTE: ALL BENDS SHALL BE

MADE COLD. TIE OR STIRRUP YPICAL REINFORCING BAR BENDS


MIN. D' = 2'' FOR #4

MIN. 'D' = $2 \frac{1}{2}$ " FOR #5

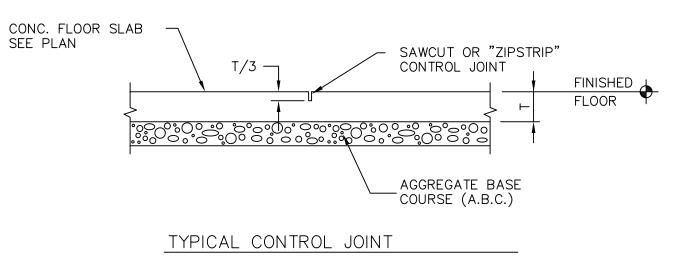


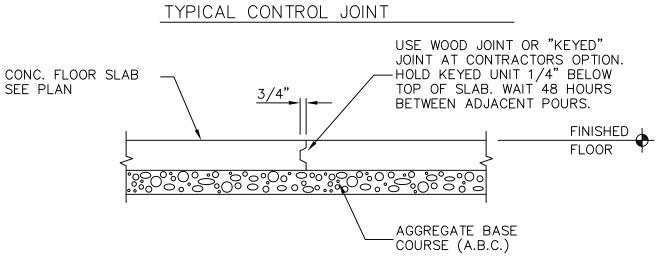

TYP. KEYED CONSTRUCTION JOINT TYPICAL CONCRETE FLOOR JOINTS

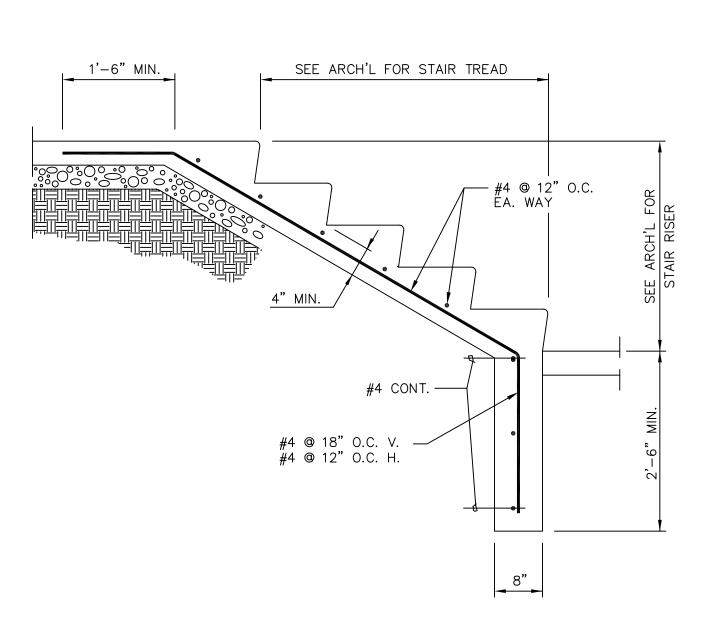



CONCRETE STAIR ON GRADE

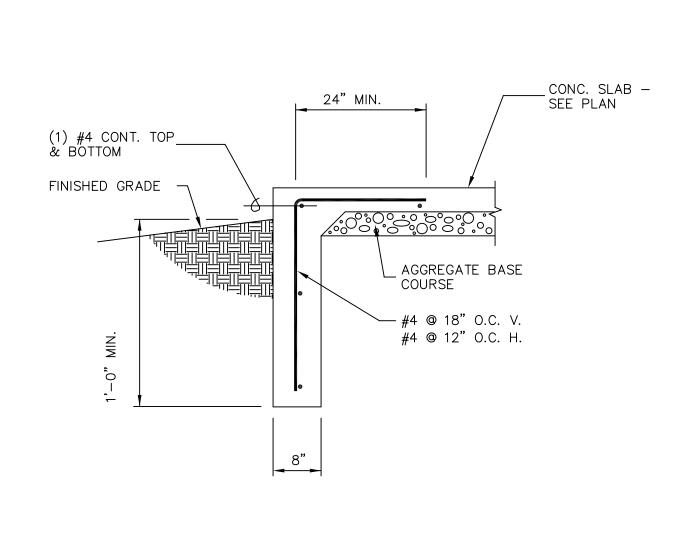

TYPICAL TURNDOWN FOOTING

77 West 200 South, Suite 302 Salt Lake City, UT 84101 Tel 801/328-2982 Fax 801/328-2111 architecture

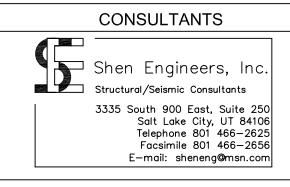

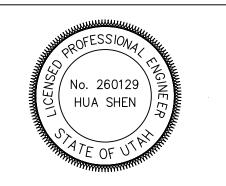

CONTROL


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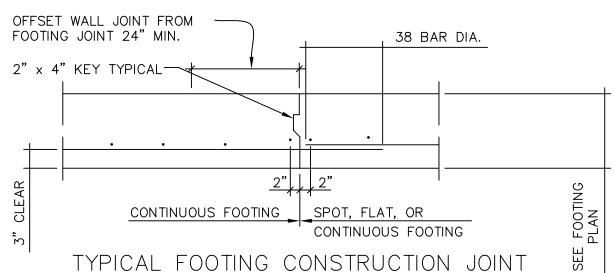
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PROJECT NUMBER: SE05190 DRAWING FILE: ΥX DRAWN BY: HS CHECKED BY: COPYRIGHT 2003 EATON ARCHITECTURE, LLC


SHEET TITLE

S-101



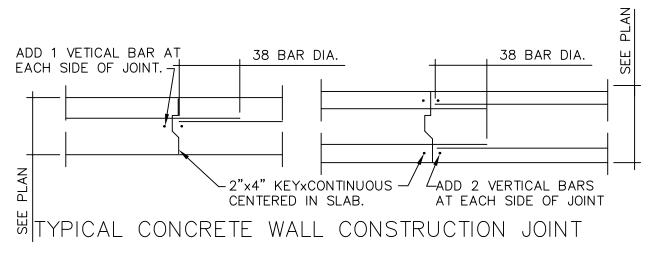

10 TYP. FTG. & WALL CONSTRUCTION JOINT

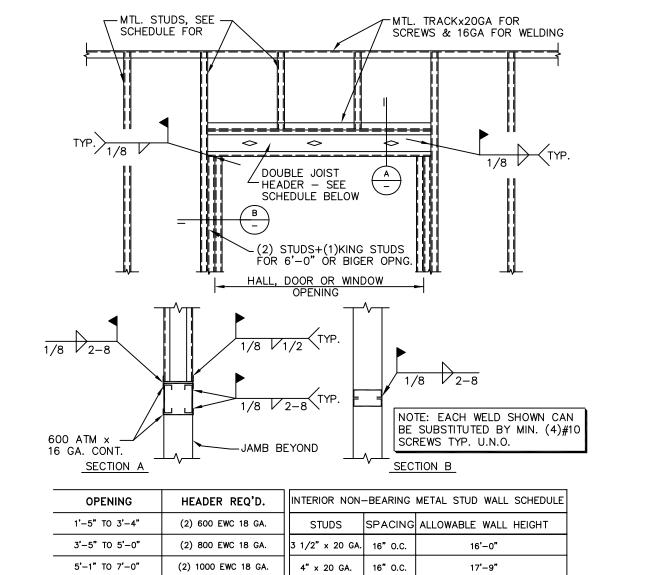



FOR 6" STUD USE 2 1/2"x16 GA W/1/2" FLANGE

FOR 3 5/8" OR 4" STUD USE 1 1/2"x16 GA W/

1/2" FLÁNGE HORIZONTAL BRIDGING.

(2) 1000 EWC 16 GA.


HORIZONTAL BRIDGING.

6" x 20 GA. | 16" O.C.

6" x 18 GA. | 16" O.C.


24'-7"

26'-7"

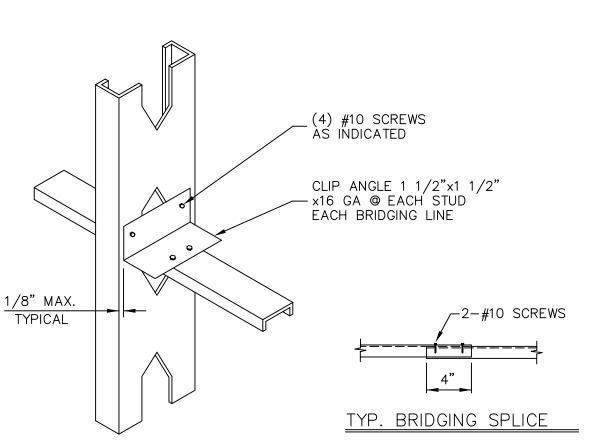


TYPICAL METAL WALL STUD BRIDGING

SEE PLAN

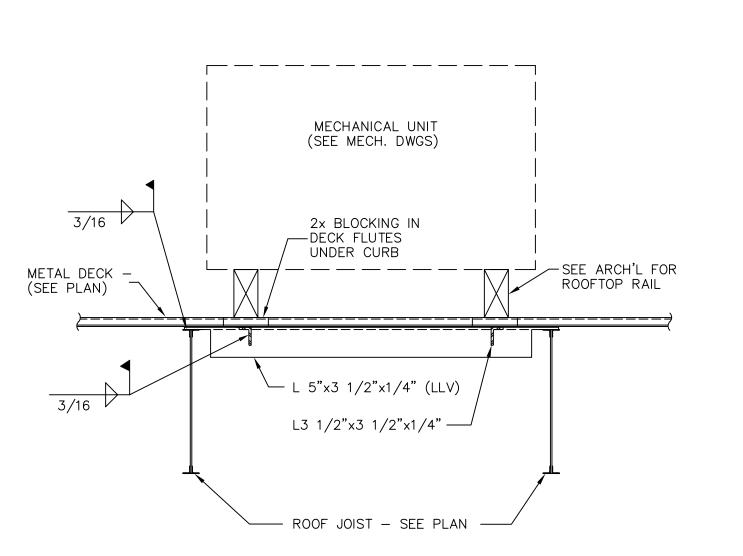


TYPICAL MECHANICAL UNIT SUPPORT

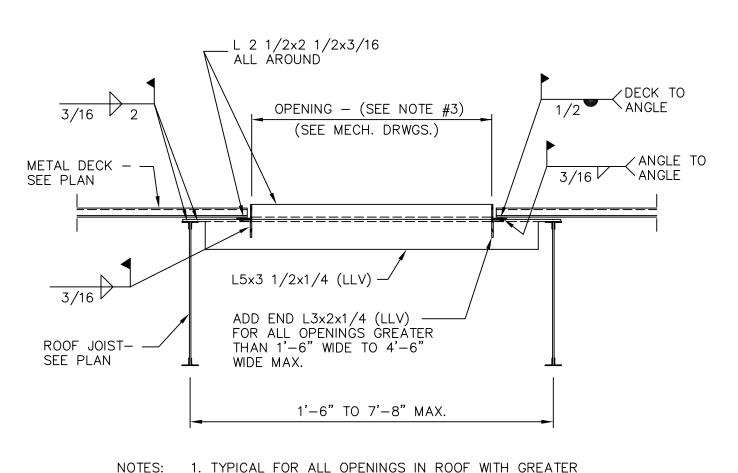


THAN 12" DIMENSION. 2. METAL DECK SUPPLIER TO FURNISH ALL SUMP PANS AND REINFORCING PLATES FOR OPENINGS UP TO 12".


3. MISCELLANEOUS STEEL CONTRACTOR TO VERIFY WITH ALL TRADES, FOR NUMBER AND LOCATION OF FRAMED OPENINGS REQUIRED.

TYPICAL FRAMING @ ROOF OPENING

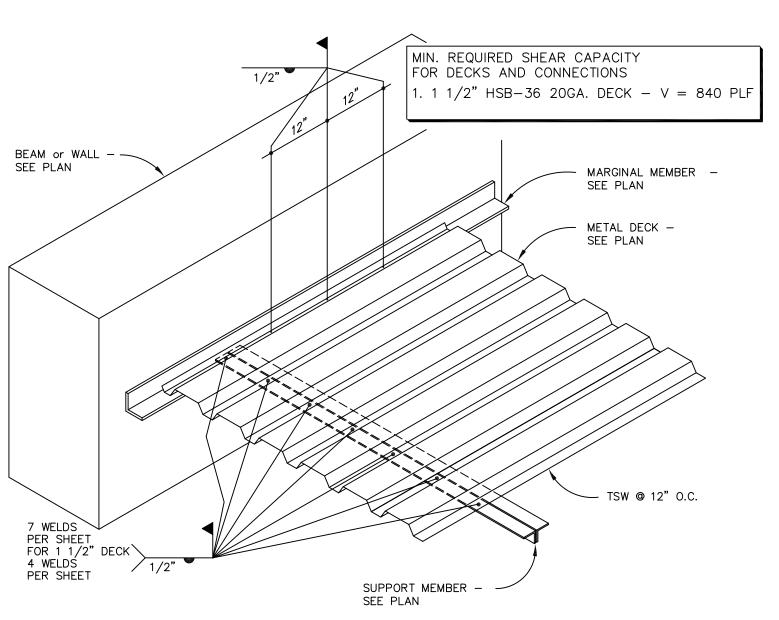


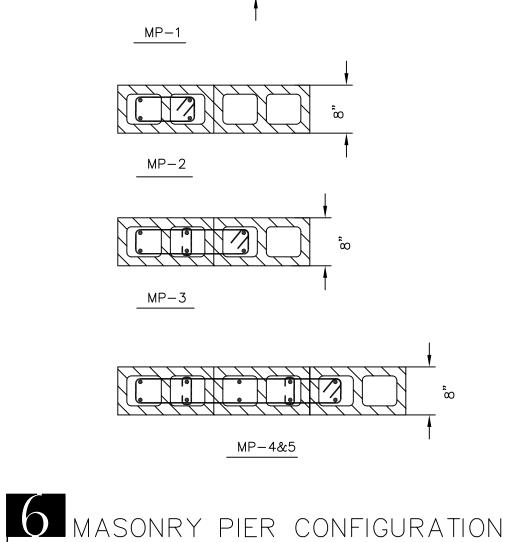


ALL REINFORCING TO EXTEND A MINIMUM OF 2'-0" BEYOND JAMBS AND BE GROUTED SOLID FOR DEPTH "D". IN LIEU OF PREMOLDED TYP. VERT. REINFORCING JOINT FILLER, PROVIDE ALL CONCRETE MASONRY UNITS USED IN LENGTH OF LINTEL TO BE -EACH SIDE OF JOINT INTO STACKED HEAD JOINT. "OPEN-END" TYPE, TO INSURE FULLY GROUTED HEAD JOINTS. SOLID GROUTED CELLS RAKE JOINT & CAULK FULL HEIGHT ALL LINTELS TO BE PROPERLY SHORED DURING GROUTING AND REMAIN IN PLACE FOR A MINIMUM OF 7 DAYS FOLLOWING GROUTING. ALL GROUT TO BE MINIMUM OF 2000 PSI AT 28 DAYS. PREMOLDED JOINT MASONRY WALL

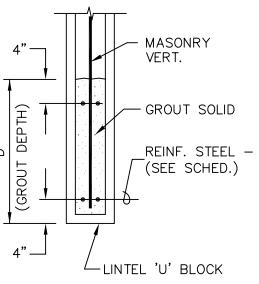

MASONRY LINTEL SCHEDULE

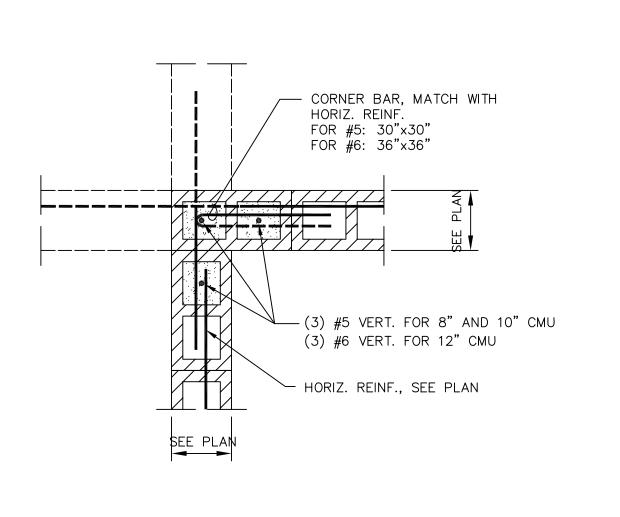

TYP. REINF. @ CORNER OR INTERSECTION OF WALLS

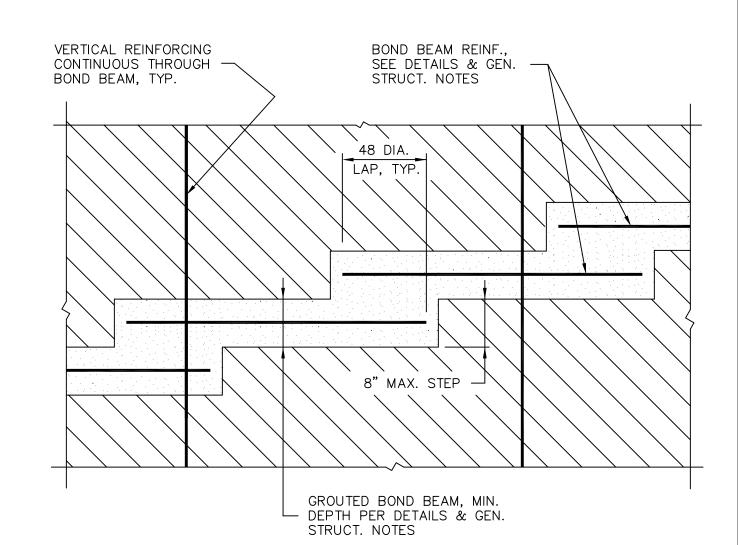

ALL HORIZONTAL JOINT REINFORCING DISCONTINUES

LOCATE AT 50'-0" O.C. MAXIMUM BUT NOT LESS THAN 2'-0" FROM BEARING PLATE OR JAMB OF AN OPENING

2. SEE ARCHITECTURAL DRAWINGS FOR CONTROL JOINTS


TYPICAL MASONRY WALL CONRTOL JOINT

SUBMIT FOR REVIEW PRIOR TO CONSTRUCTION

THRU JOINT.

AT JOINT. ALL BOND BEAM REINFORCING CONTINUES


TYPICAL STEPPED BOND BEAM

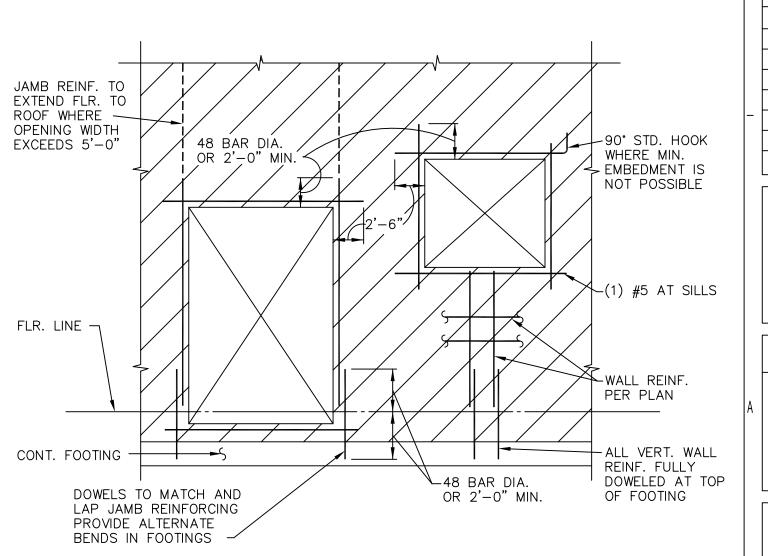

TYPICAL MASONRY WALL CONSTRUCTION

77 West 200 South, Suite 302 Salt Lake City, UT 84101 Tel 801/328-2982 Fax 801/328-2111 architecture

> CONSULTANTS 🖣 💳 Shen Engineers, Inc Structural/Seismic Consultants 3335 South 900 East, Suite 250 Salt Lake City, UT 84106 Telephone 801 466-2625 Facsimile 801 466-2656 E-mail: sheneng@msn.com

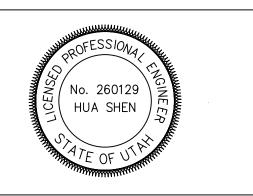

#2 TORAGE S LIQUOR **TERSON** ODGEN PAT

OWNER
DEPARTMENT OF 10/20/05 DATE DESCRIPTION

PROJECT NUMBER: SE05190 DRAWING FILE: DRAWN BY: ΥX CHECKED BY: HS

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SHEET TITLE

S-102

<u> </u>		<u> </u>	
	FOOTIN	G SCHEDUI	SBP=2500PSF SEE SOIL REPORT
MARK	SIZE	REINFORCING	REMARKS
F1	2'-0" × CONT. × 12"	(2) #4 CONT.	
F2	5'-6" SQ. x 12"	(6) #6 E.W.	
F3	16" × CONT. × 12"	(1) #4 CONT.	THICKENED SLAB

FOUNDATION PLAN NOTES: . SEE GENERAL STRUCTURAL NOTES SHEET

AND STANDARD CONCRETE DETAIL SHEET FOR A. GENERAL STRUCTURAL NOTES
B. TYPICAL EXCAVATION ADJACENT TO

TYPICAL SLAB JOINT DETAILS
TYPICAL STEPPED FOOTING 2. WS - DENOTES CONCRETE WALL STEP.

3. F-1 - DENOTES FOOTING MARK - SEE FOOTING SCHEDULE. 4. K.C.J. - DENOTES KEYED CONSTR. JOINT -SEE STANDARD DETAIL.

5. C.J. - DENOTES CONTROL JOINT - SEE STANDARD DETAIL. 6. F----S - DENOTES FOOTING STEP, SEE DETAIL TYPICAL. 7. CONTRACTOR TO VERIFY ALL DIMENSIONS

AND ELEVATIONS WITH ARCHITECTURAL


DRAWINGS PRIOR TO CONSTRUCTION. SEE ARCHITECTURAL FOR ALL DIMENSIONS, SLAB SLOPES & DEPRESSIONS NOT NOTED. 8. ALL SLABS ON GRADE ARE TO BE JOINTED AT NO MORE THAN 15'-0" EACH WAY USING JOINTS AS PER STANDARD DETAIL. IN ADDITION, NO SECTION OF CONCRETE SHALL HAVE AN ASPECT RATIO OF GREATER THAN 1 1/2:1. PROVIDE (2) #4 x 4'-0" MID-HEIGHT SLAB BARS ADJACENT TO ALL DISCONTINUOUS JOINT LOCATIONS. ALL COLUMN ISOLATION JOINT CORNERS ARE TO BE INTERSECTED BY A SLAB JOINT OR REINFORCED WITH SLAB BARS PER ABOVE. SUBMIT COMPLETE JOINT LAYOUT PLAN TO THE ARCHITECT FOR PRIOR REVIEW.

9. ALL WOOD TO CONTACT w/ CONC. OR MASONRY TO BE P.T. OR REDWOOD TYP. 10. ALL FOUNDATION PL. ANCHOR BOLTS TO USE A MIN. 2x2x3/16 PL. WASHERS TYP.

77 West 200 South, Suite 302 Salt Lake City, UT 84101 Tel 801/328-2982 Fax 801/328-2111

> CONSULTANTS Shen Engineers, Inc.

Structural/Seismic Consultants 3335 South 900 East, Suite 250 Salt Lake City, UT 84106 Telephone 801 466-2625 Facsimile 801 466-2656 E-mail: sheneng@msn.com

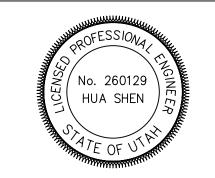

#2 TORAGE S LIQUOR TERSON PAT

ODGEN

DATE DESCRIPTION

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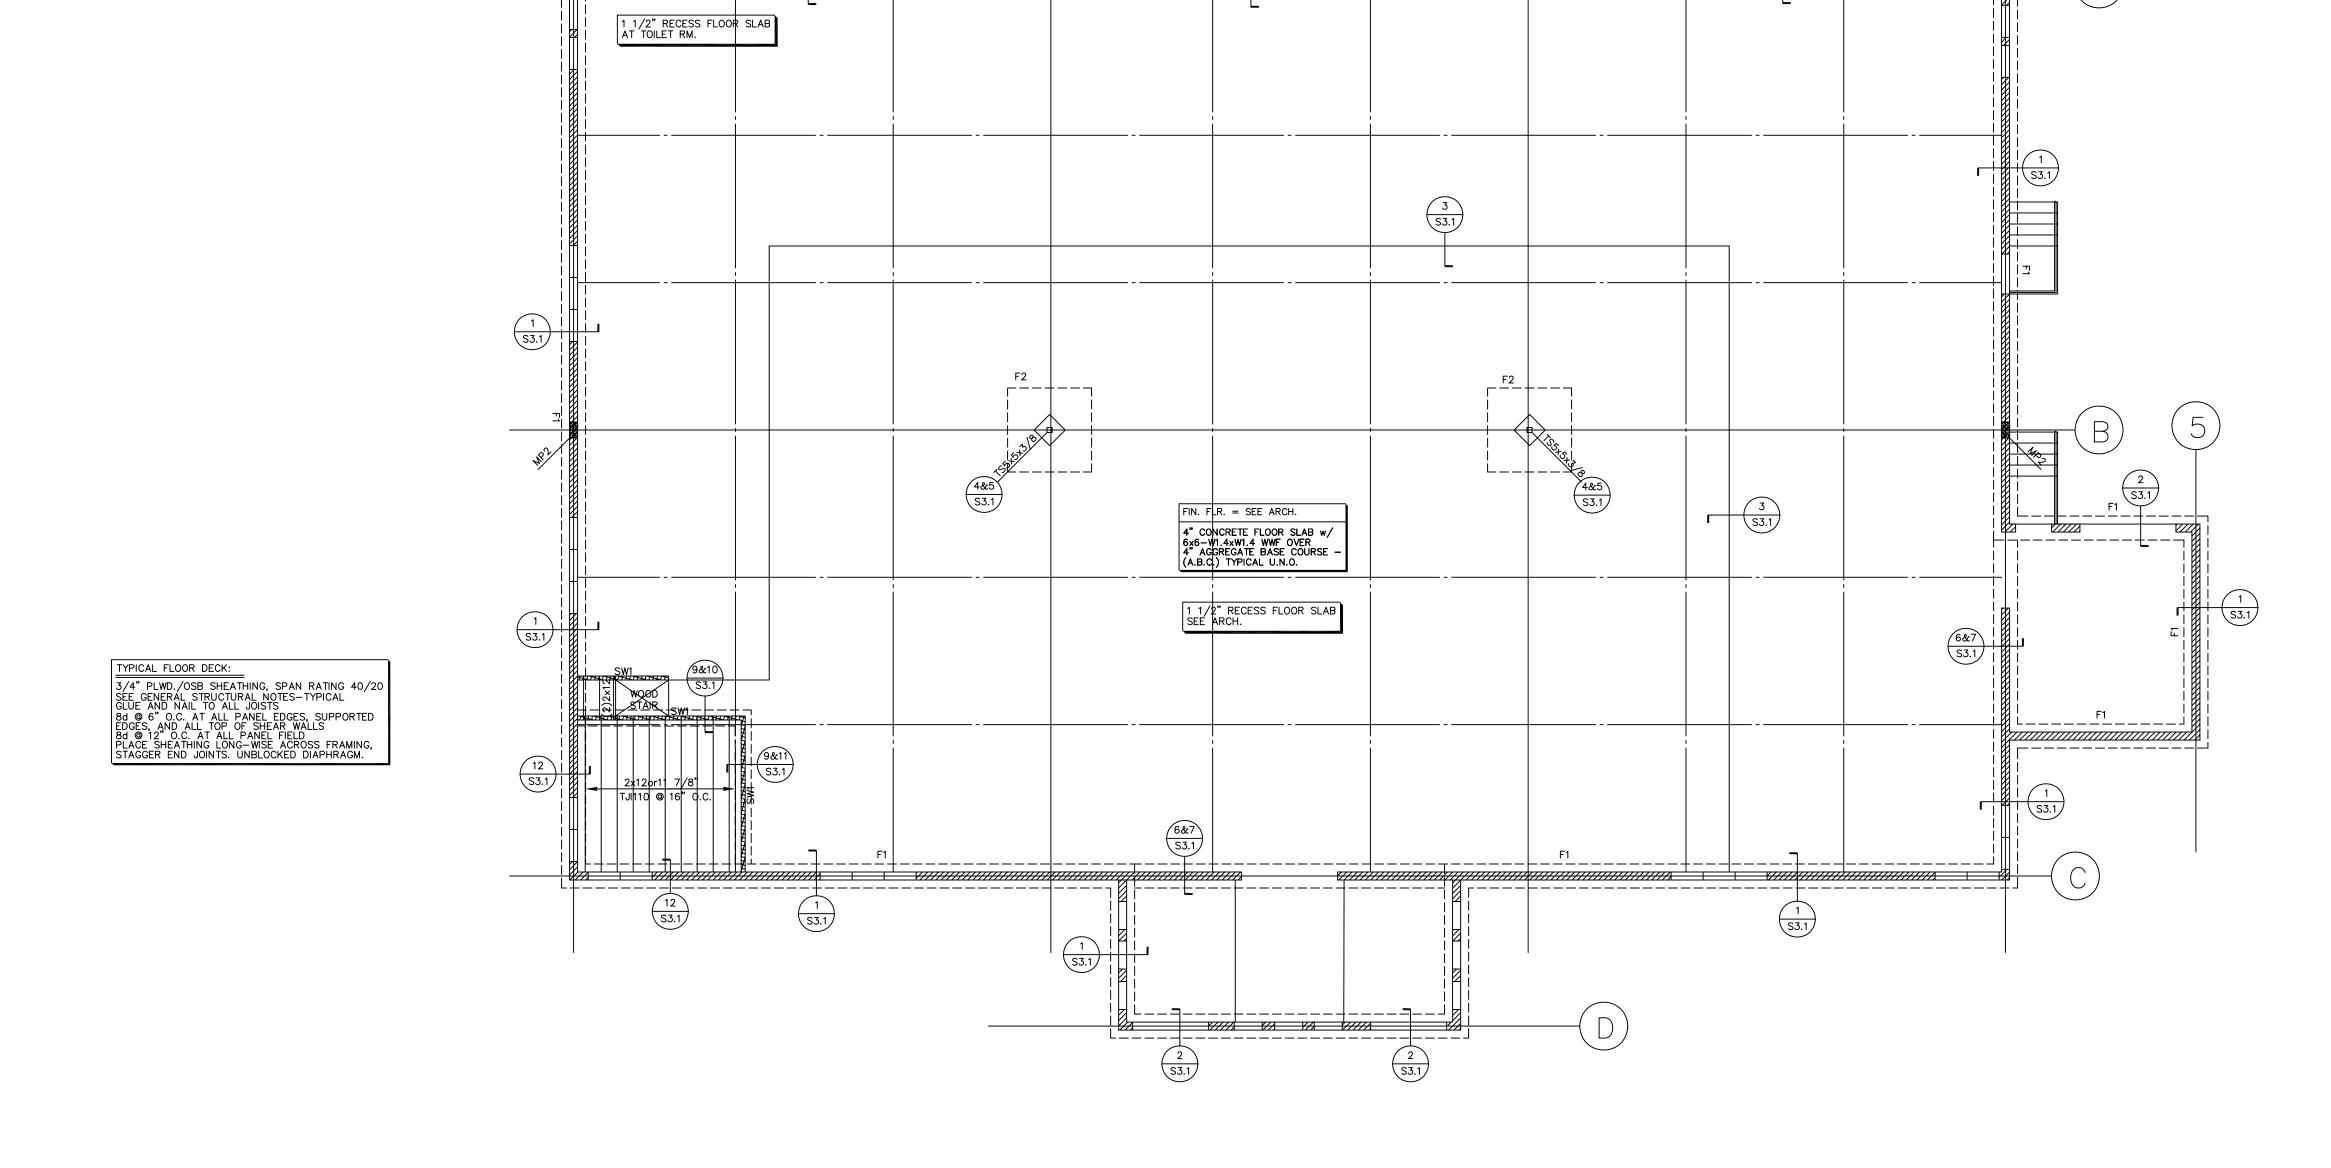
SHEET TITLE

S-201

CONCRETE (TYPICAL).

BOLSTERED AND SUPPORTED AND ALL REBAR IS IN PLACE AND 5. DO NOT PERMIT FIN. GRADE TO COME CLOSER THAN 6" TO TOP OF

CONCRETE. 6. BEARING SURFACES FOR PRECAST CONCRETE, STEEL OR TIMBER MEMBERS SHALL BE PREPARED TO A TRUE AND LEVEL LINE.



CONCRETE POUR NOTES:

. VERIFY FTG STEP LOCATIONS AND HEIGHT WITH ARCHITECT IN FIELD PRIOR TO FORMING FOOTINGS. MAKE FTG REBAR CONTINUOUS THROUGH FTGS WITH BENT BARS AT CORNERS. LAP BARS 40 BAR DIAMETERS AT SPLICES AND TIE.

2. THE DIMENSIONS ARE TO FACE OF CONCRETE UNLESS OTHERWISE NOTED. NOTE THAT DIMENSIONS ON ARCITECTURAL PLANS ARE TO FACE OF STUD AND FACE OF STUD IS 1" OUT FROM FACE OF

ACCURATELY LOCATE ANCHOR BOLTS AND HOLDDOWNS FROM THE ARCHITECTURAL PLAN AND VERIFY WITH THE ARCHITECT PRIOR TO PLACING CONCRETE. . DO NOT POUR ANY CONCRETE UNTIL THE FORMS ARE ADEQUATELY

SHEARWALL SCHEDULE PLYWOOD EDGE NAILING INTER. NAILING PLATE ANCHOR POLTS PANEL EDGE TO TOP PL.
STUD WHERE DRAG
OCCURS SW1 1/2" (C-D, C-C) 8d @ 6" O.C. 8d @ 12" O.C. 2xPL. 3/4" Ø A.B. x 10" @ 48" O.C.

1/2"(C-D,C-C) PLWD CAN BE SUBSTITUTED BY 7/16" OSB TYP. U.N.O..

ROOF FRAMING PLAN

1	ĺ		2			1
ROOF FRAMING PLAN NOTES:		MARK	SIZE OF LINTEL	REINFORCING	MIN. END BRG.	REMARKS
1. SEE SHEET S1.1 AND S1.3 FOR:					END BRG.	
A. GENERAL STRUCTURAL NOTES B. TYPICAL ROOF METAL DECK		ML-1	8"×16"	(2) #5 T&B	MP-1	
WELDING PATTERN C. TYPICAL ROOF OPENING DETAIL		ML-2	8"x16"	(2) #6 T&B	MP-1	
D. MECH. UNIT SUPPORT DETAILS E. MASONRY LINTEL SCHEDULE		ML-3	8"×40"	(4)#5 B/(2)@5 T	MP-2	
2. J. B. = ROOF JOIST BEARING ELEVATION.				•		
3. PROVIDE JOIST BRIDGING PER S.J.I.						
4. ESTABLISH AND VERIFY ALL OPENINGS & INSERTS FOR MECHANICAL, ELECTRICAL & PLUMBING WITH THE APPROPRIATE TRADES, DRAWINGS AND SUBCONTRACTORS PRIOR TO CONSTRUCTION.						
5. JOIST & JOIST GIRDER DESIGNATIONS DO NOT INCLUDE MECHANICAL WEIGHTS. DESIGN JOISTS & JOIST GIRDERS @ MECH. UNITS TO SUPPORT WEIGHTS INDICATED @ ANY POINT						

WITHIN 5 FEET EITHER WAY ALONG THE SPAN.
6. JOIST MANUF. TO ADJUST ALL JOIST SIZES

AND DESIGN STRESSES AS REQUIRED BASED ON THE SPECIFIC UL RATING NOTED ON THE

8. HANGING CEILING, DUCTWORK OR OTHER ITEMS FROM THE ROOF METAL DECK IS

9. DENOTES MECH. UNIT APPROX.
LOCATION AND MAXIMUM WEIGHT.
COORDINATE WITH MECH. DWG's.
PROVIDE SUPPORT AND OPENING

DENOTES OPENING IN ROOF DECK
COORDINATED SIZE & LOCATION
W/ MECH. DRAWINGS. PROVIDE
OPENING FRAMES PER DETAILS
ON SHEET S1.3.

FRAMES PER DETAILS ON SHT. S1.3.

ARCHITECTURAL DRAWINGS.

NOT ALLOWED.

		MAS	ONRY W	ALL SCHE		VEL II SF n=2000	PECIAL INSPECTION ON CMU TYP. PSI	
	MARK	WALL THICKNESS	VERT. REINF.	HORIZ. REINF.	BOND BM. @ ROC	F LVL	REMARKS	
	MW1	8"	#5 @ 32" O.C.	#5 @ 48" O.C.	8"x8" MIN. w (2)#5 HORIZ.	// (GROUT CELLS w/REBARS. TYP. FOR 8" CMU WALLS U.N.O.	
	MW1	8"	#5 @ 24" O.C.	#5 @ 48" O.C.	8"x8" MIN. w (2)#5 HORIZ.	′/ (GROUT CELLS w/REBARS.	
•	1. TERMINATE HORIZ. REBARS AT WALL JOINTS TYP.							

HIGH ROOF FRAMING PLAN

SCALE 1/4" = 1'-0"

1.	TERMIN	IATE	HORI	Z. REBA	ARS	ΑТ	WALL	JOINTS	TYP.		
2.	CONTIN	NUE	HORIZ	. REBA	RS F	OR	BOND	BEAM	AT WALL	JOINTS	TYP.
3.	SOLID	GRO	JT AL	L CELL	S FC	DR 1	WALLS	UNDER	FINISHED	GRADE	TYP.

	MASONRY PIER SCHEDULE						
MARK	SIZE	REINF.	TIES	MIN. BRG. PL SIZE FOR BM./GIRDER			
MP-1	8" × 8"	(2) #5	NONE	1/2"x7"x7" PL. w/ (1) 3/4"ø H.S. x5"			
MP-2	8" x 16"	(4) #5	#2 @ 8" O.C.	1/2"x7"x14" PL. w/ (2) 3/4"ø H.S. x5"			
MP-3	8" × 24"	(6) #5	#2 @ 8" O.C.	3/4"x7"x22" PL. w/ (3) 3/4"ø H.S. x5"			

NOTE: SEE DETAIL 6/S1.3 FOR CMU PIER REINFORCEMENT CONFIGURATION TYPICAL.

MP-1 IS TO BE APPLIED @ EA. END OF OPENINGS MIN. TYP. U.N.O.

77 West 200 South, Suite 302
Salt Lake City, UT 84101
Tel 801/328-2982 Fax 801/328-2111

Shen Engineers, Inc.	
Structural/Seismic Consultants 3335 South 900 East, Suite 250 Salt Lake City, UT 84106 Telephone 801 466—2625 Facsimile 801 466—2656 E—mail: sheneng@msn.com	



	10/20/05	
MARK	DATE	DESCRIPTION

PROJECT NUMBER:	SE05190
DRAWING FILE:	
DRAWN BY:	YX
CHECKED BY:	HS

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SHEET TITLE	


S-202


1 S4.1 ML2 ML2	1 S4.1 ML2 ML2 ML2 ML2	ML2	1 S4.1)	4) (A)
2 M 2 M 2 M 2 M 2 M 2 M 2 M 2 M 2 M 2 M	ML2 ML2 2.50 VA WM. W.	8K7 @ 6'-8" O.C. 8K7 @ 6'-8" O.C.	2 M 2 M 2 M 2 M 2 M 2 M 2 M 2 M 2 M 2 M	3 3 10 S4.1

ROOF FRAMING PLAN

SCALE 1/4" = 1'-0"


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\text{N Version: 13_c4} 8. 1996 3:28:37 p.m.

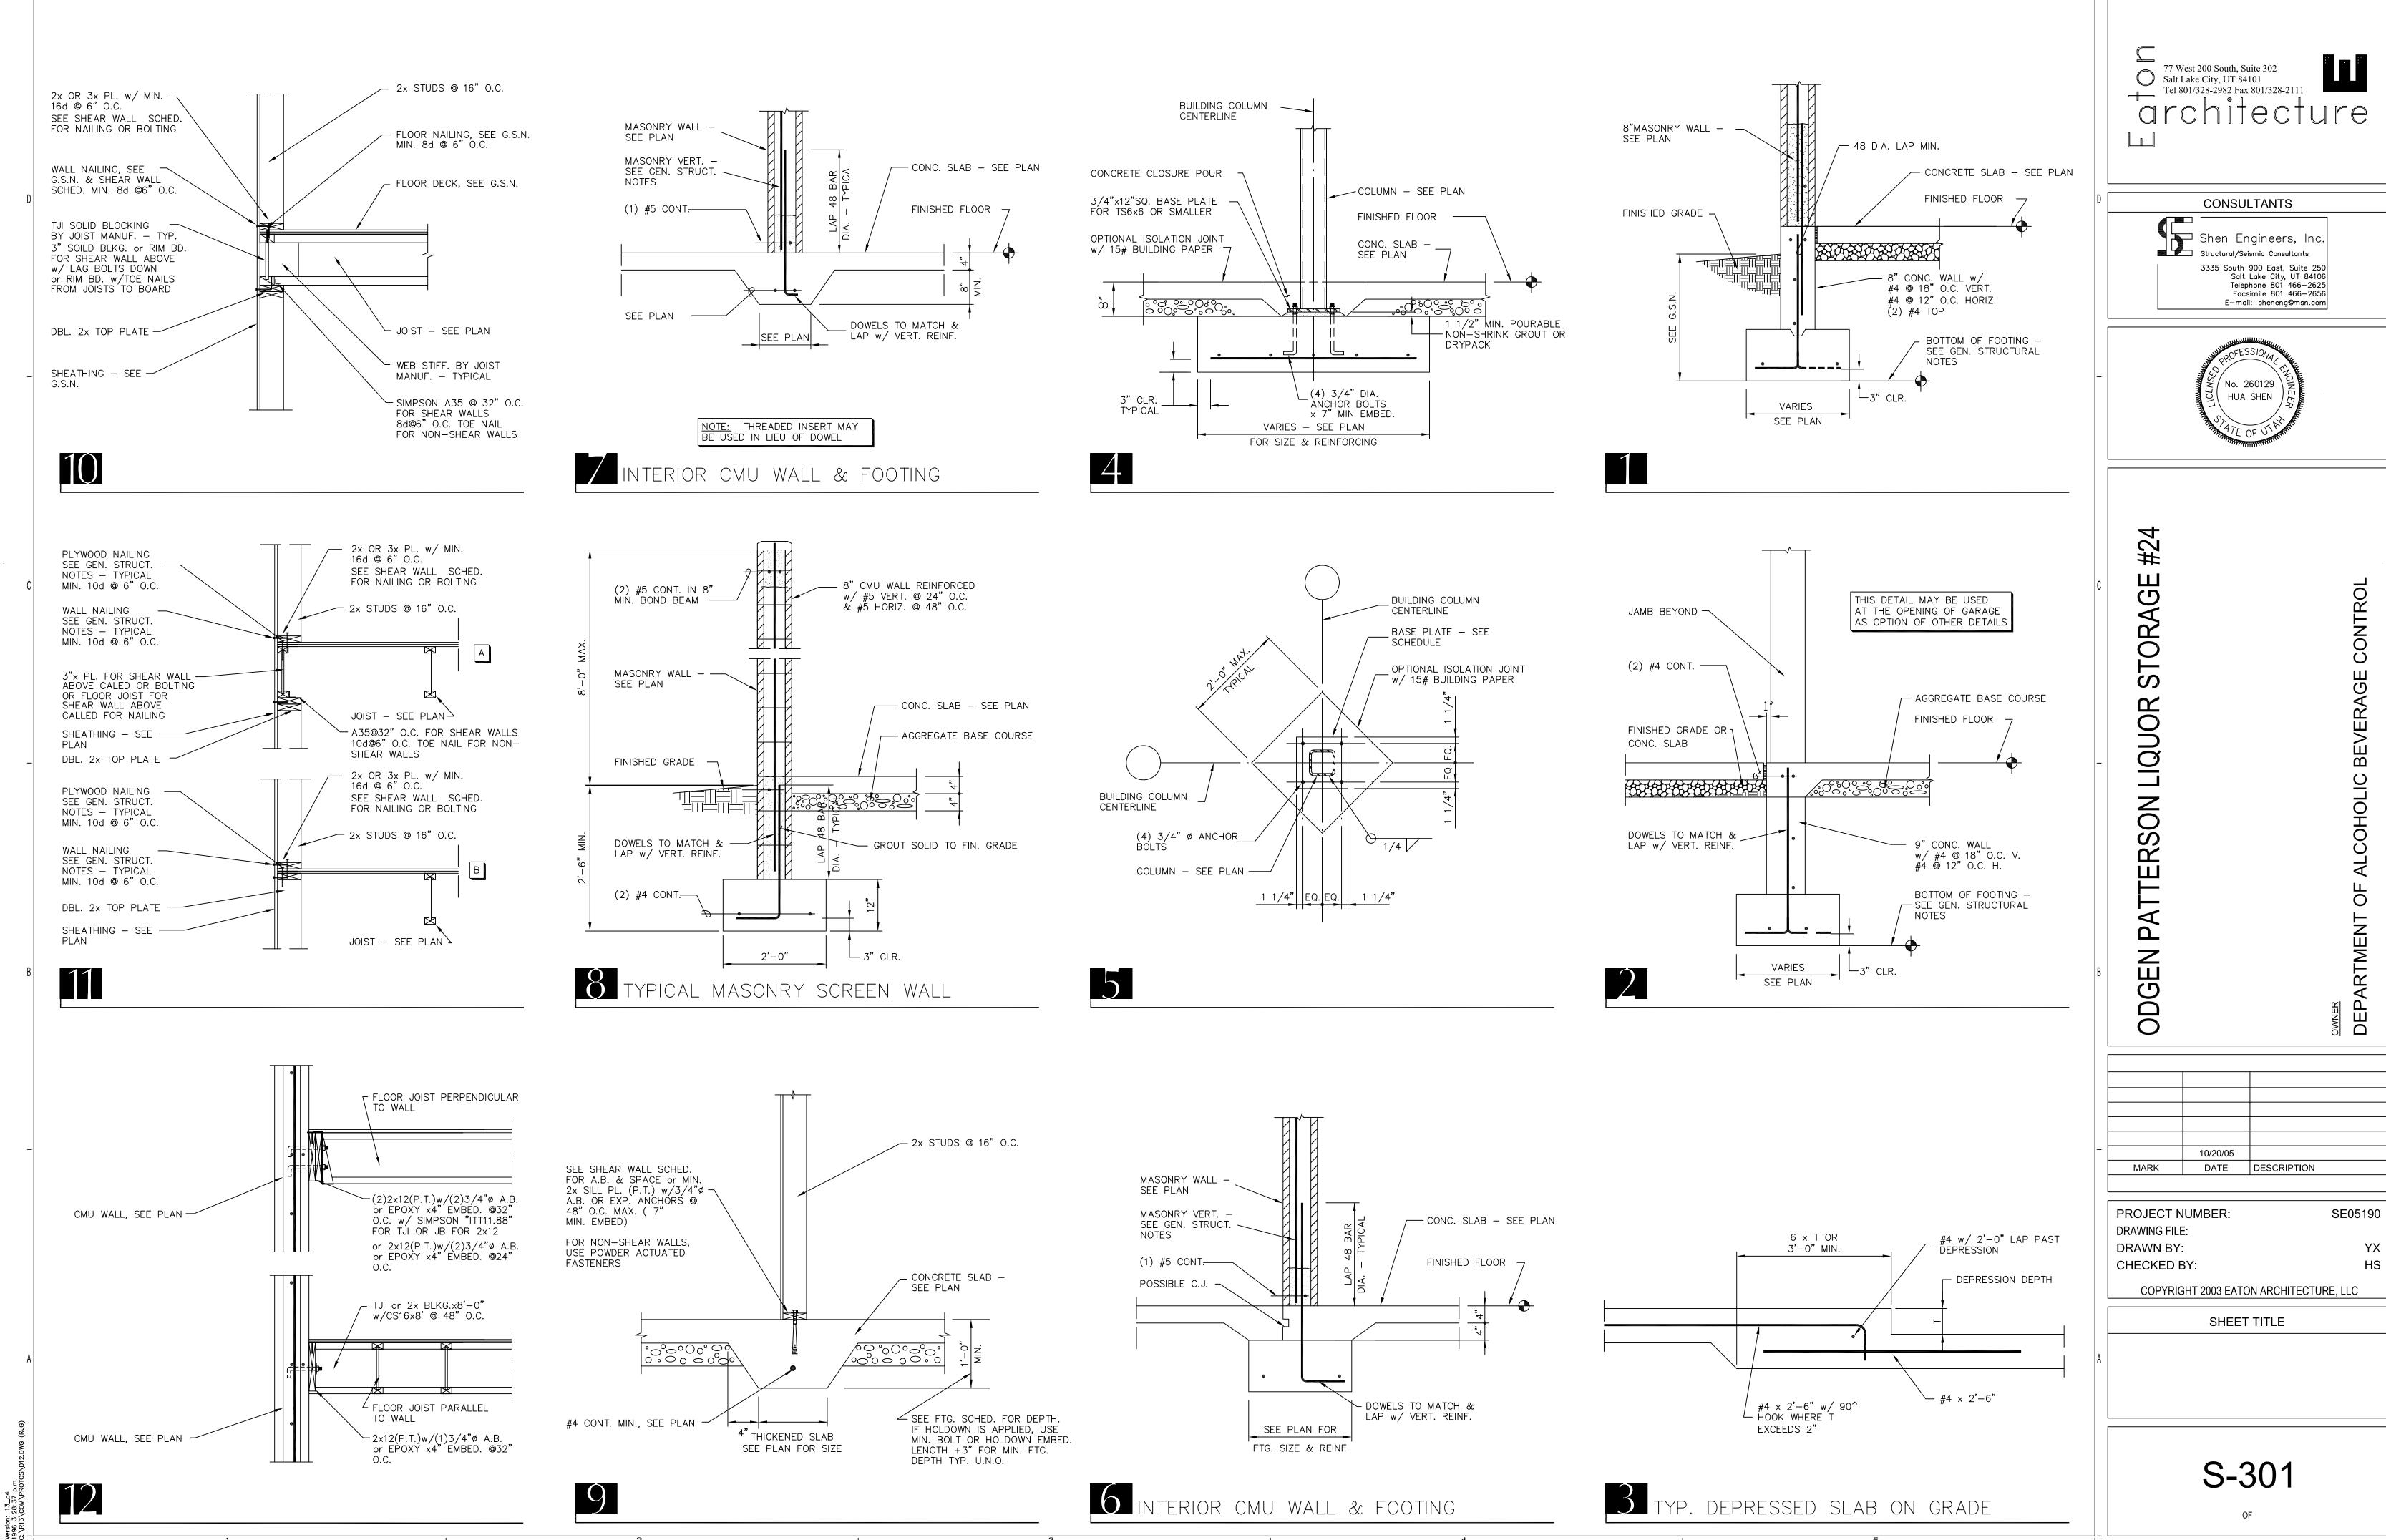

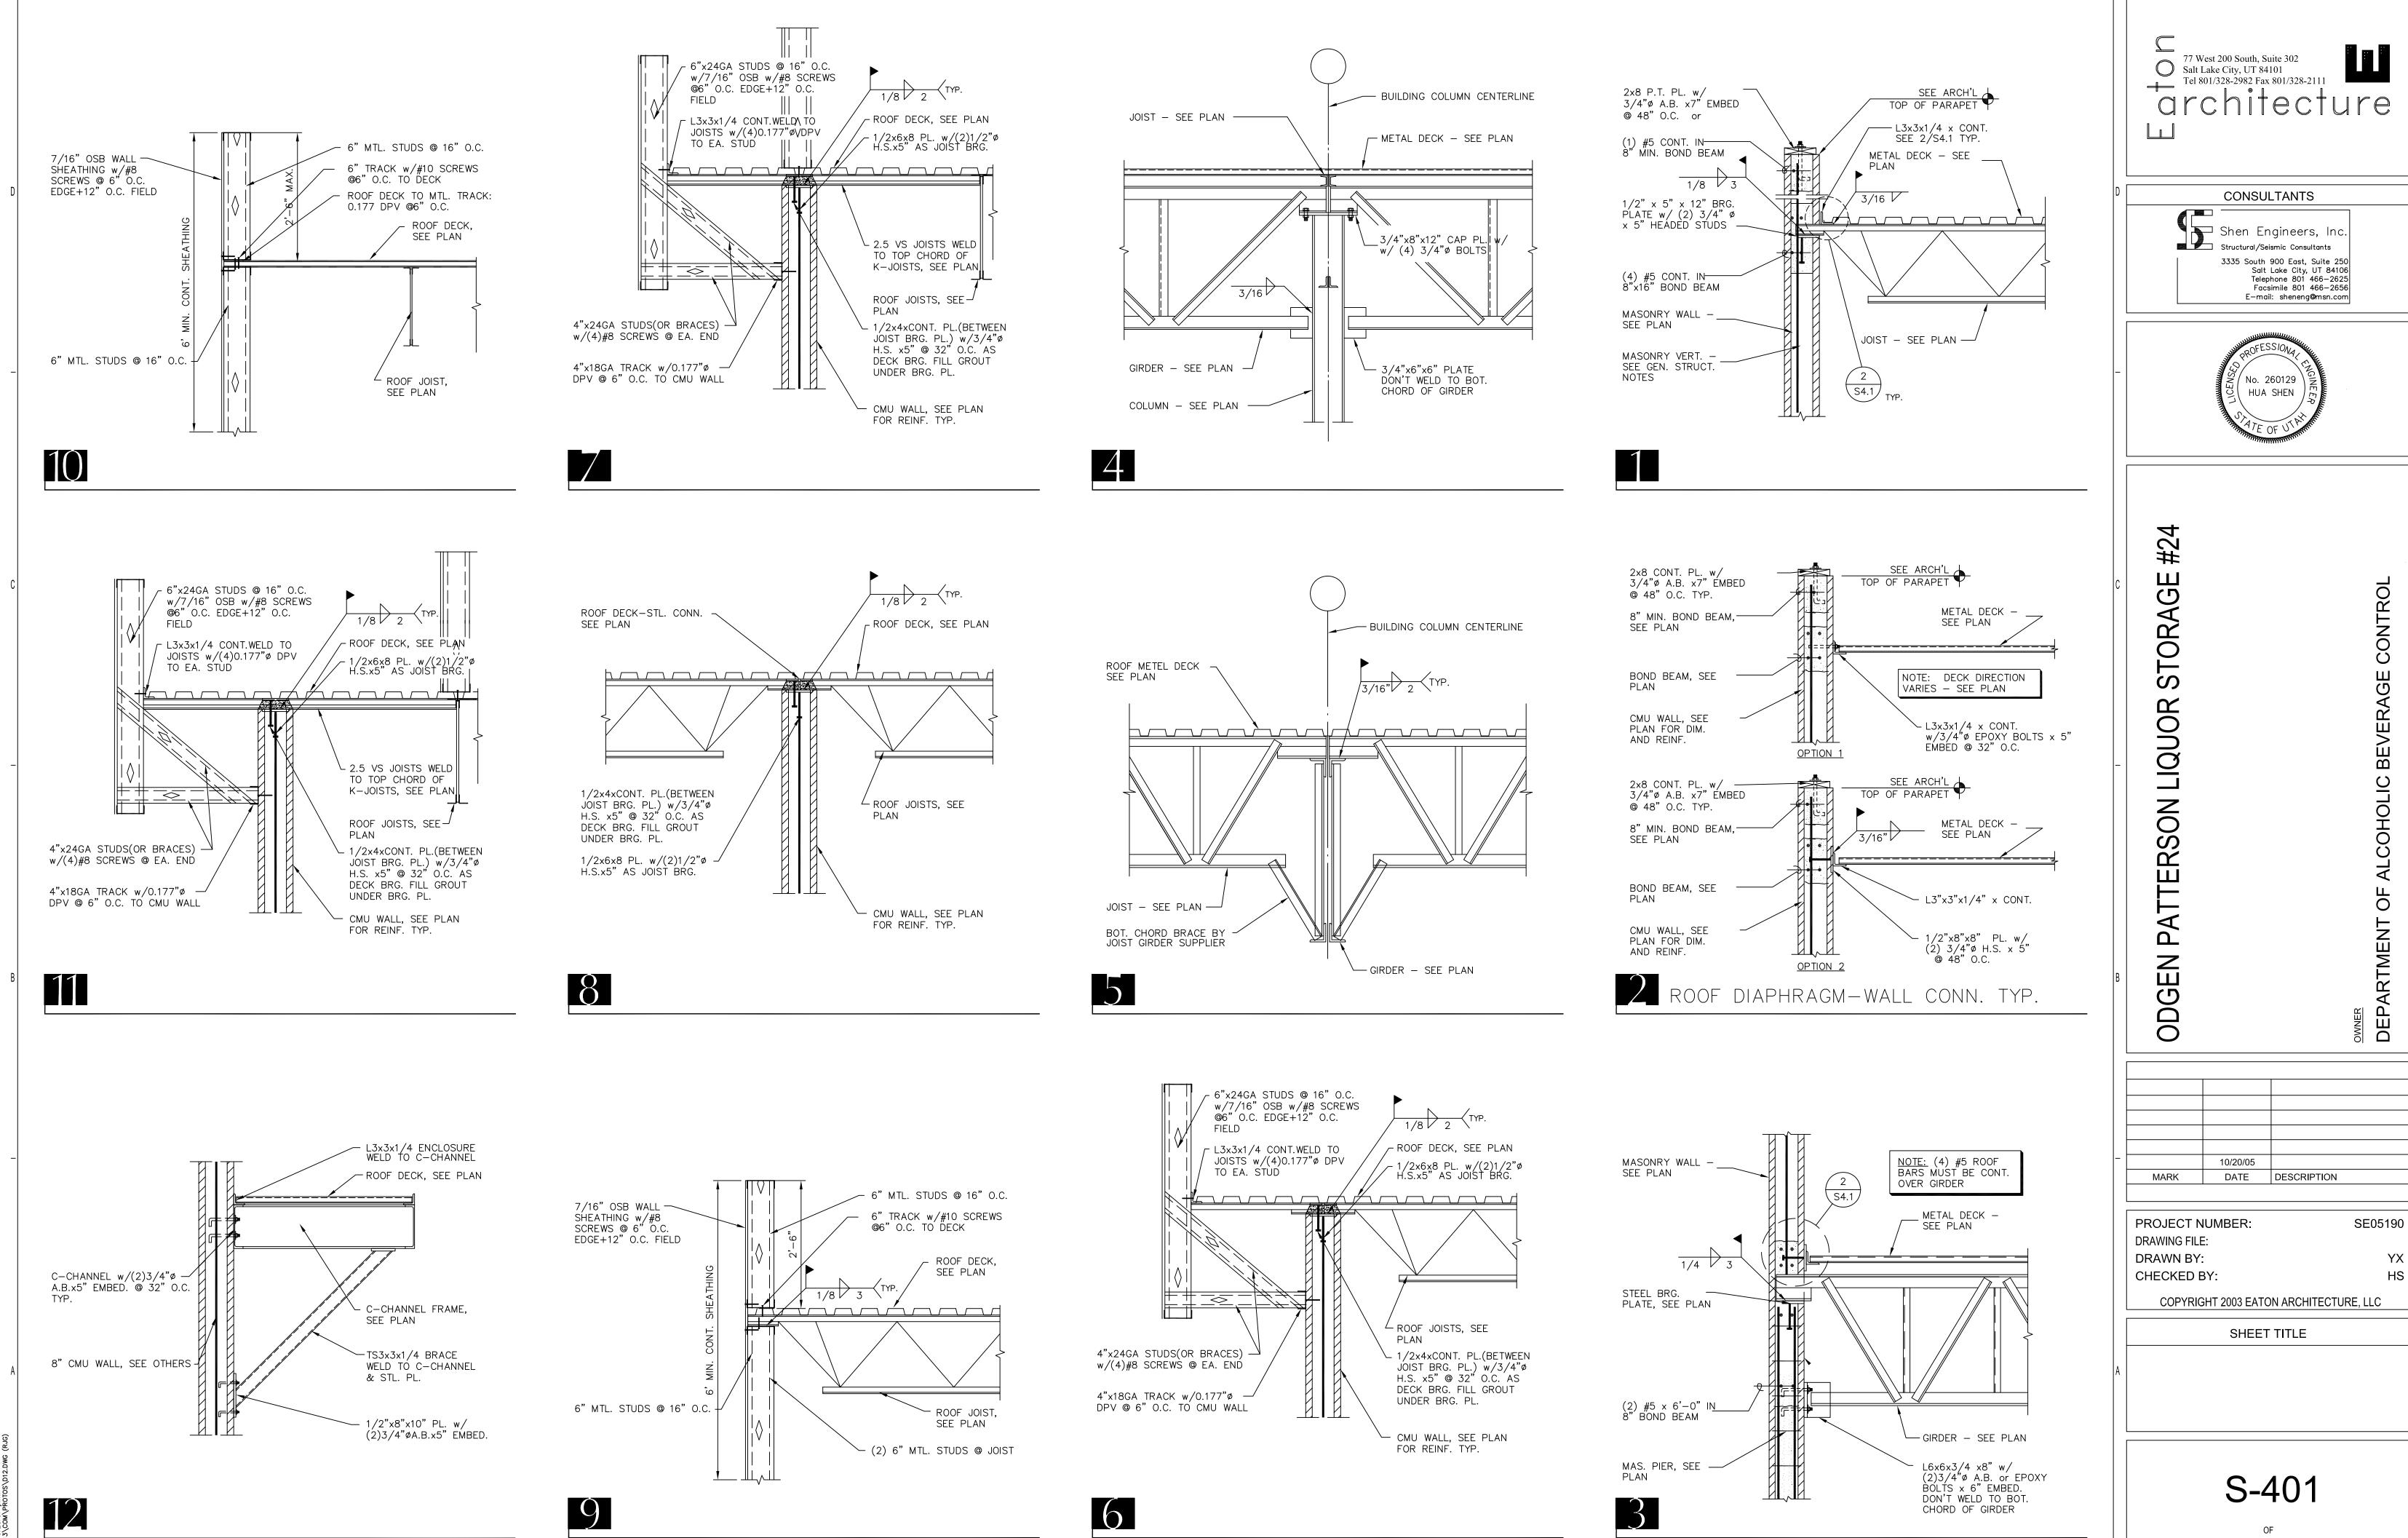

MECHANICAL LEGEND

 \triangle

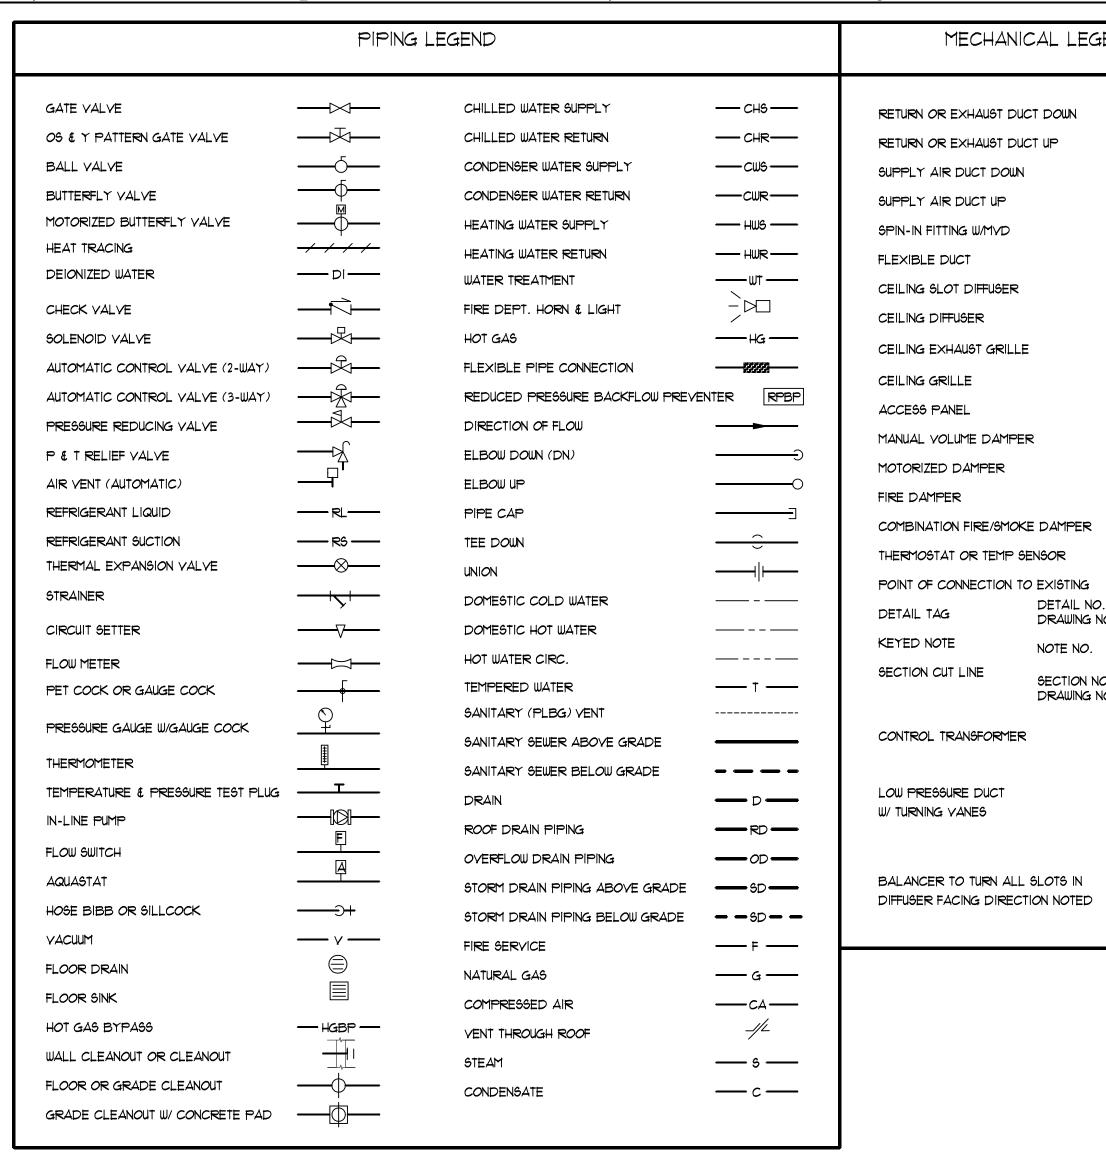 \boxtimes

TRX

DETAIL NO. -

NOTE NO.

DRAWING NO.

SECTION NO.

DRAWING NO.

		PLUM	IBING FIX	KTURE C	ONNECT	TION SCHEDULE
			CONNECT	TION SIZE		
	DESCRIPTION	COLD WATER	HOT WATER	WASTE	YENT	SPECIFICATIONS
WC-1	WATER CLOSET (HANDICAP)	3/4"	N/A	3"	21/2"	KOHLER K-3544-RA, SEAT: OLSONITE 95 COMFORT CURVE, COLOR: WHITE. PROVIDE SUPPLIES AND STOP. SET RIM AT $17^{1/2}$ " AFF.
WC-2	WATER CLOSET (HANDICAP)	3/4"	N/A	3"	2½"	KOHLER K-3544, SEAT: OLSONITE 95 COMFORT CURVE, COLOR: WH PROVIDE SUPPLIES AND STOP. SET RIM AT $17\frac{1}{2}$ " AFF.
L-1	LAVATORY	V ₂ "	V ₂ "	11/2"	11/4"	KOHLER: GREENWICH WALL MOUNT K-2031-N W/ ACCESSORY MODEL #102G FOR HANDICAP INSTALLATION & K-8998 TRAP FAUCET: SYMMONS ULTRA SENSE S-6080-G W/ GRID DRAIN POWER HYDROGUARD SERIES 480 TEMPERING VALVE.
HB-1	HOSE BIBB	3/4"	N/A	N/A	N/A	WOODFORD: MODEL 74P-34
FD-I	FLOOR DRAIN	N/A	N/A	SEE PLANS	N/A	J. R. SMITH 2005 W/ A05NB NICKEL/BRONZE STRAINER AND TRAP PRIMER
F5-1	FLOOR SINK	N/A	N/A	SEE PLANS	N/A	J. R. 9MITH 3140-12-Y W/ NICKEL/BRONZE TOP/ 1/2 GRATE AND TRAP PRIMER
SC-1	SILLCOCK	3/4	N/A	N/A	N/A	J. R. 9MITH 5509QT (W/ INTEGRAL VACUUM BREAKER AND STAINLESS STEEL BOX)
WCO-1	WALL CLEAN OUT	N/A	N/A	SEE PLANS	N/A	J. R. 9MITH 453Ø
FCO-1	FLOOR CLEAN OUT	N/A	N/A	SEE PLANS	N/A	J. R. SMITH 4023
RD-1	ROOF DRAIN	N/A	N/A	N/A	N/A	J.R. SMITH 1010Y - C - R - CI DOME PROVIDE CAST IRON DOME.
<i>O</i> D-1	OVERFLOW DRAIN	N/A	N/A	N/A	N/A	J.R. SMITH 1080Y - C - R - CI DOME PROVIDE CAST IRON DOME.
D5N-1	DOWNSPOUT NOZZLE	N/A	N/A	N/A	N/A	J.R. SMITH 1770
WHA	WATER HAMMER ARRESTORS	AS REQUIRED	AS REQUIRED	N/A	N/A	J. R. 6MITH 5020
55- 1	SERVICE SINK	3/4"	3/4"	3"	½"	KOHLER: K-6710 w/K-9142 STRAINER FAUCET: CHICAGO FAUCET MODEL # 897-RCF
5- 1	SINK (SS 2 COMPARTMENT)	l/ ₂ "	V ₂ "	2"	11/4"	JUST: DLX-1829-A-GR WITH J35 STRAINER FAUCET: CHICAGO FAUCET MODEL # 786-SWE29CP PROVIDE W/ GARBA DISPOSAL UNIT GDU-I: ISE MODEL PRO 77, I hp, II5 V, I p, 9.0 a
EWC-1	ELECTRIC WATER COOLER	1/2"	N/A	11/2"	11/4"	SUNROC: NWCA-8-BL (BI LEVEL FOUNTAIN) 7.8 gph, 4.5 FLA, 415 Watts, 120v - 10, R-134A

				A	IR DOME AD-	
PLAN CODE	AREA SERVED	DAMPER TYPE	OPENING SIZE	OPERATING WT. (LBS.)	MANUFACTURER / MODEL	COMMENTS
AD-1	ENTIRE BLDG.	GRAVITY	16" x 16"	8Ø	PENN DOMEX DRIG	WITH FACTORY 14" HIGH CURB

		ŧ	ELECT	RIC WATER	HEA1	ER S	CHEDULE WH-	
51 451	NEUT	RECOVERY	TEMP		ELEC	TRICAL	MANUFACTURER	
PLAN CODE	NPU (KW)	RATE (GAL/HR)	RISE (°F)	DIMENSIONS	VOLT & PHASE	AMPS	& MODEL NO.	REMARKS
WH-1	2,500	13	8Ø	26" x 18" x 21"	2 0 8 / 1	10.4	A.Ø. SMITH DEL-15	WITH AMTROL 5T-5 EXPANSION TANK

	3	EXHAUST	6"Ф	See Plans	15	17Ø	PRICE 6"Ф / 12" × 12" / PDDR / 2 / B12
	4	EXHAUST	14" × 14"	See Plans	31	49Ø	PRICE 10"\$ / 16" x 16" / PDDR / 2 / B12
	ь	SUPPLY	8"Ф	See Plans	2Ø	28Ø	PRICE 8"Ф / 24" × 24" / 9CDA / 3 / BI2
	6	SUPPLY	1Ø"Φ	See Plans	2Ø	42Ø	PRICE 10"Ф / 24" × 24" / 6CDA / 3 / B12
	7	SUPPLY	12"Ф	See Plans	2Ø	560	PRICE 12"Ф / 24" x 24" / SCDA / 3 / BI2
	8	SUPPLY	8" Ф	See Plans	2Ø	24Ø	PRICE 8"\$ / 24"\$ / RCD / BI2
	9	SUPPLY	1ØΦ	See Plans	2Ø	38Ø	PRICE 10"¢ / 24"¢ / RCD / BI2
	10	SUPPLY	12"Ф	See Plans	20	550	PRICE 12"Ф / 24"Ф / RCD / BI2

NECK SIZE

10" x 22" | See Plans

22" x 22" | See Plans

RETURN

RETURN

MANUFACTURER

& MODEL NO.

OUTPUT REQ'D.

ELEVATION

CEILING TYPE

									i	ROOF TOP (INIT SCHED	DULE F	RTU-							
PLAN CODE	UNIT TONAGE	TOTAL CFM	EXTERNAL STATIC PRESSURE	OUTSIDE	GN CRITE RETURN AIR DB		LEAVING AIR TEMP	EER	SENSIBLE COOLING CAPACITY (MBH)	HEATING CAI INPUT (MBH)	PACITY OUPUT (MBH)	VOLTS PHASE	LECTRICA MCA	L MOP	DIM! Length	ENSIONS Width		OPER. WEIGHT (lbs)	MANUFACTURER & MODEL NO	REMARKS
RTU-1 & RTU-2	12.5	4,800	0.6	95	80	62	54.3/53.2	9.6	102.99	208.0	168.90	208 / 3	63.Ø	80	107	71	65	1,950	TRANE YCD15ØD3HO	SEE GENERAL NOTES

54.3/53.2	9.6	102.99	208.0	168.90	208/3	63.0	80	1Ø7
NERAL	NOTE	S:						

(3) PROVIDE FACTORY HACR CIRCUIT BREAKER.

9 PROVIDE 7 DAY PROGRAMMABLE T-STAT WITH 100 Ft. OF PLEMUN RATED T-STAT WIRE. PROVIDE FACTORY MOUNTED CONV. OUTLET TO BE FIELD WIRED.

(1) PROVIDE SMOKE DETECTOR IN SUPPLY & RETURN AIR DUCTWORK. (5) PROVIDE FACTORY 2 lb. GAS TRAIN. (2) PROVIDE COIL GUARDS.

① ALL ROOFTOP UNITS MUST MEED OR EXCEED CURRENT ASHRAE ENERGY CODE 90.1 STANDARDS.

() VALUES ARE RATED AT 4,500 Ft. ELEVATION.

2 PROVIDE MINIMUM DUTSIDE AIR SET POINTS.

4 PROVIDE ECONOMIZER, AND POWER EXHAUST.

PROVIDE COMPRESSOR CRANKCASE HEATER.

PROVIDE 14" FACTORY CURB.

							E×	HAUST	FAN SCHEDULI	EF-				
PLAN CODE	AREA SERVED	TYPE	CFM @ ELEV.	ESP	FAN RPM	MC WATTS	VOLTAGE & PHASE	SONES	DAMPER TYPE	METHOD OF CONTROL	OPENING SIZE	OPERATING WT. (LBS.)	MANUFACTURER / MODEL	
EF-1 thru. EF-4	RESTROOM	CEILING	100	Ø.75	1,050	84	12Ø / 1	3.7	GRAVITY	WALL SWITCH	6" x 8"	45	PENN ZEPHYR Z819(TDA)	PROVIDE CEILING GRILLE

										12 1	, , , , , , ,		
		10	Su	IPPLY	12"Ф	See Plar	ns 20	E	550	12"Φ .	PRICE / 24"¢ / RC	D / Bl2	
]												
GAS	FIRE	D UN	11T H	EATER	SCHE	DULE	UH-						
SPECIFI	IED UNIT (CAP.	CFM	THROW	AT	ELECTRICA	AL ,	-LUE		SI	IZE		
INPUT	OUTPU (S.L.)	JT (6	STD.)	12' MOUN1 (FT.)	. 1 *		44.1		LENGTH	MIDTH	HEIGHT	WEIGHT	REMARKS
(MBH)	(MBH)	9											

AIR DEVICE SCHEDULE

GRILLE
NUMBER

GRILLE
GRILLE
GRILLE

MANUFACTURER

& MODEL NO.

PRICE 22" x 10" / 24" x 12" / PDDR / 3 / BI2

PRICE 22" x 22" / 24" x 24" / PDDR / 3 / Bl2

REMARKS

PROVIDE W/ SOUND BOOT

PROVIDE W/ DUCT COLLAR

PROVIDE OBD

PROVIDE OBD


MAX. CFM

610

1340


N.C. LEVEL MAX

10

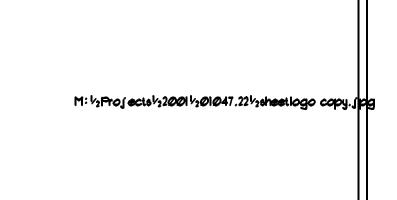

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24 # ORE S TERSON

	12-22-05	100% REVIEW
	12-16-05	REVIEW COMMENTS
	10-18-05	DESIGN DEVELOPMENT
MARK	DATE	DESCRIPTION

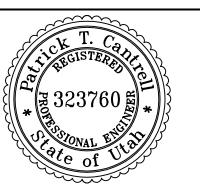PROJECT NUMBER: DRAWING FILE: DRAWN BY:

CHECKED BY:


OGDEN PAT

05156.00 See Drawing Stamp

SHEET TITLE


Mechanical Schedules

M001

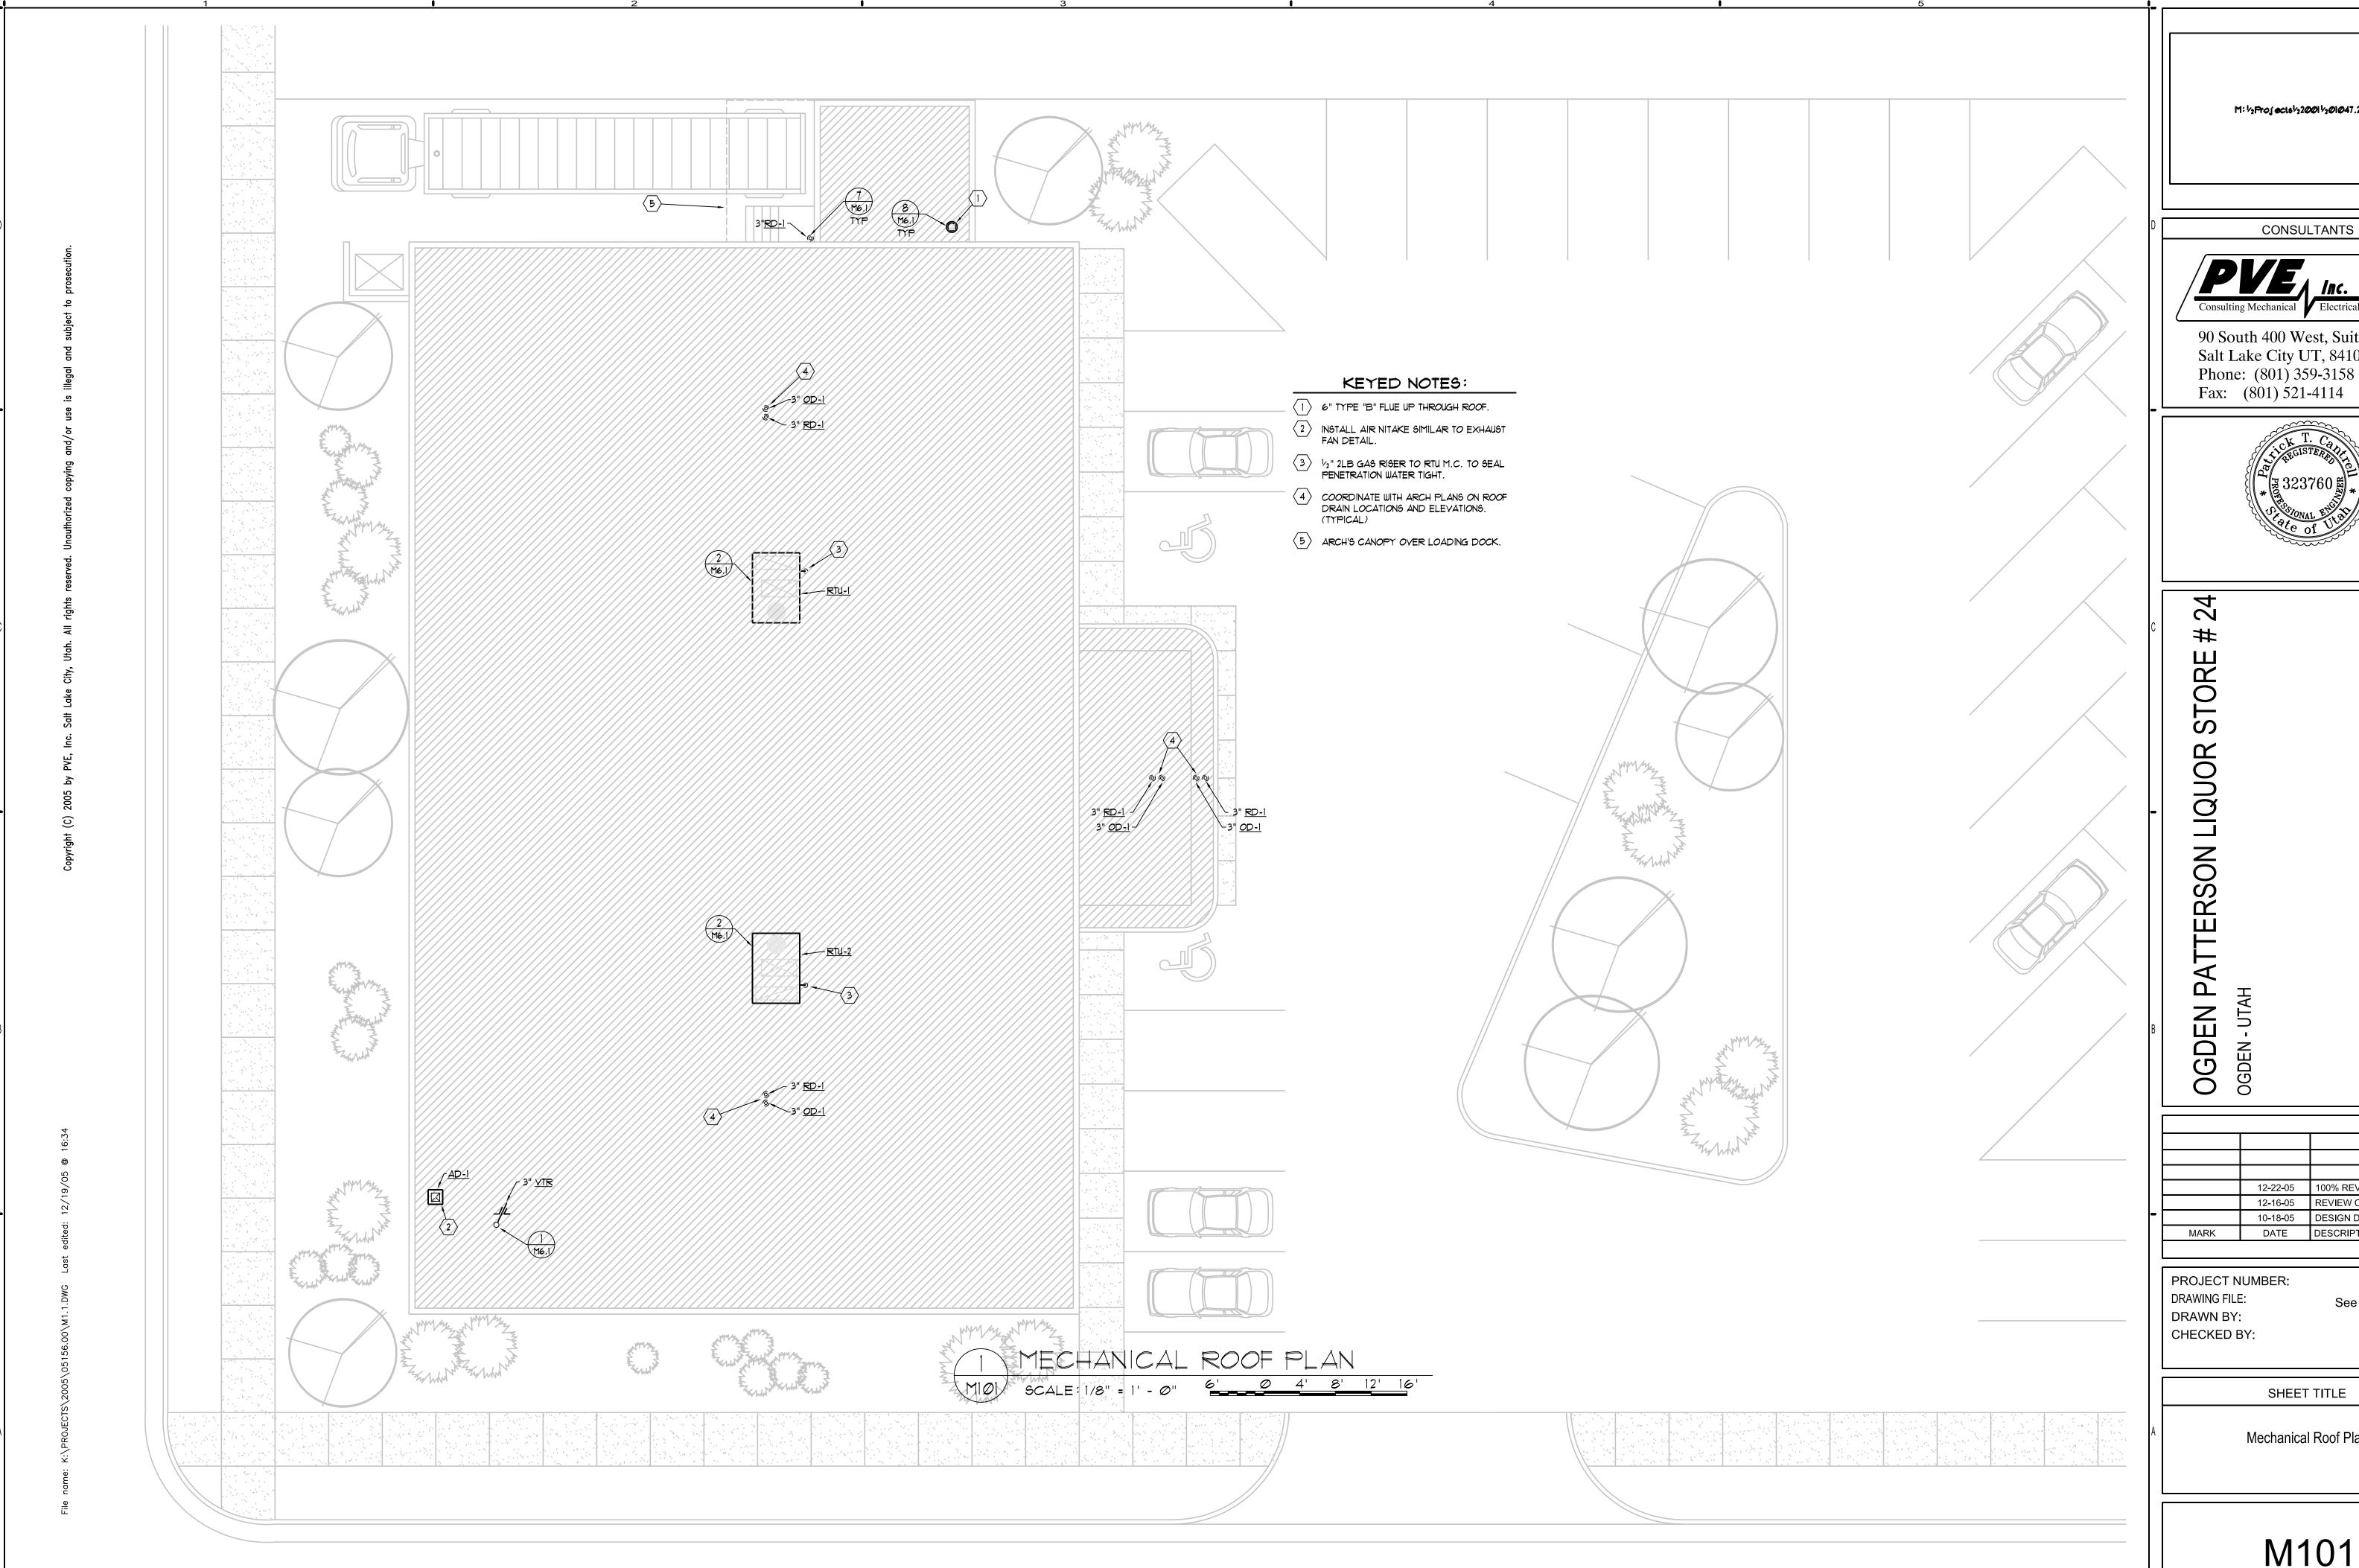

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	12-22-05	100% REVIEW
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	10-18-05	DESIGN DEVELOPMENT
MARK	DATE	DESCRIPTION


PROJECT NUMBER:

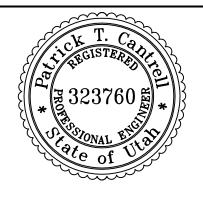05156.00 See Drawing Stamp AJG KAG

SHEET TITLE

Mechanical Roof Plan

M101

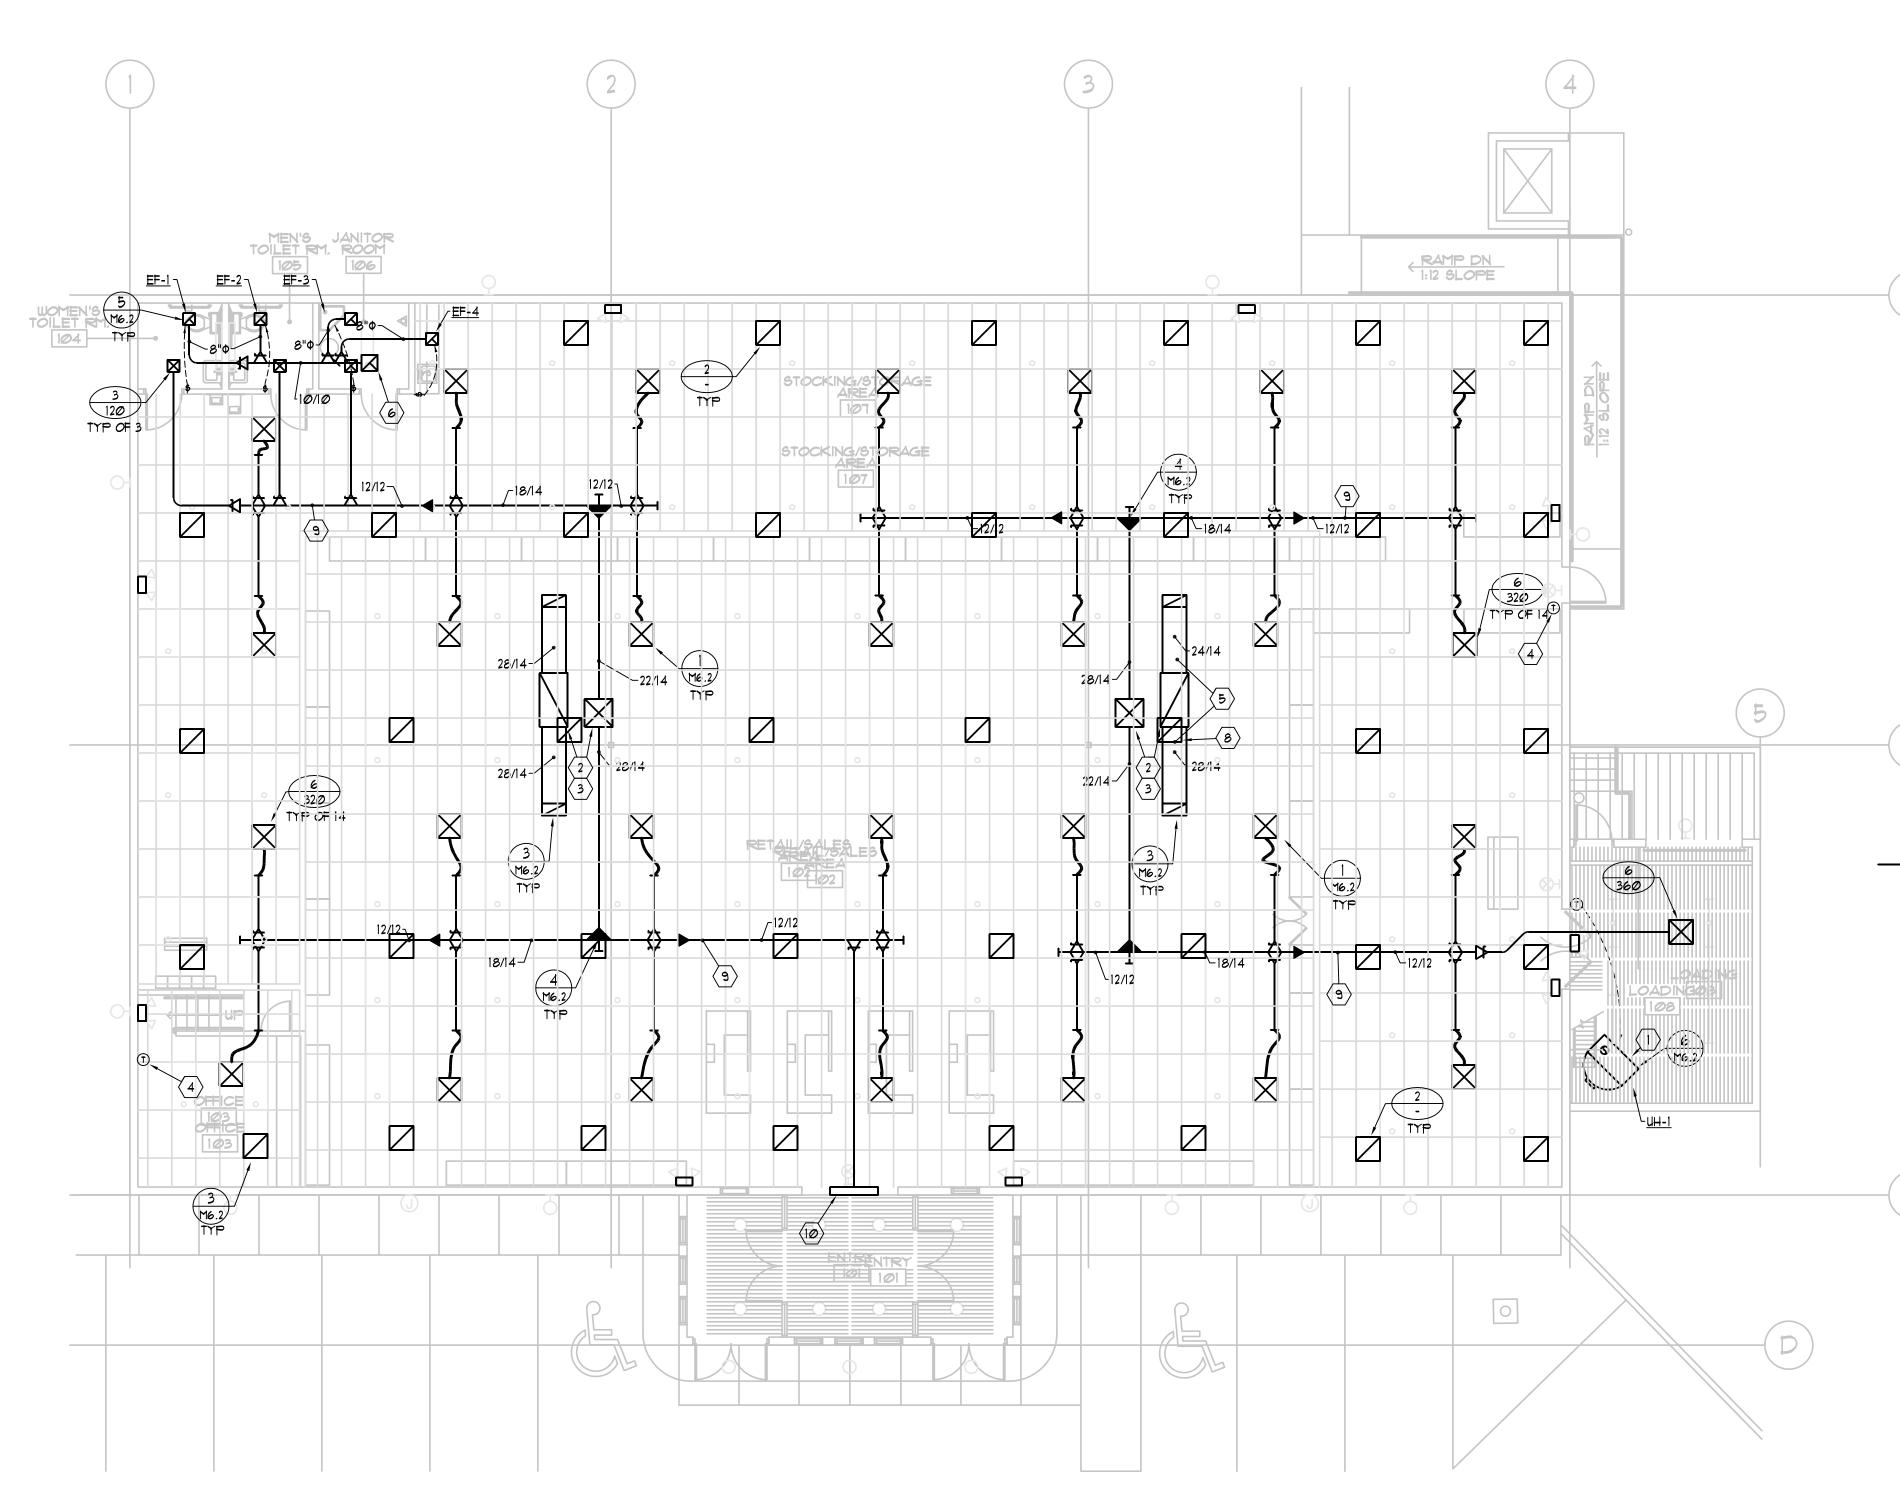

KEYED NOTES:

- 6" TYPE "B" FLUE UP THROUGH ROOF SEE DETAIL 6/M6.2
- 2 PROVIDE AND INSTALL DUCTWORK DROPS DOWN FROM UNIT SIZED FULL SIZE OF UNITS
- COORDINATE WITH ROOF STRUCTURAL AND INSTALL DUCTWORK TIGHT TO BOTTOM OF STRUCTURE. IF POSSIBLE ROUTE MAINS UP IN BETWEEN JOIST.
- COORDINATE WITH ARCH'S PLANS FOR FINAL ELEVATIONS AND LOCATIONS OF 7-DAY PROGRAMMABLE T-STAT'S.

 (TYPICAL)
- PROVIDE A MINIMUM OF 5FT. LINED
 DUCTWORK ON BOTH ENDS OF MAIN
 RETURN AIR DROP. PROVIDE ELBOW
 UPWARDS AT BOTH ENDS OF DUCTWORK.
 (TYPICAL)
- $\langle 6 \rangle$ 12"X12" RISER TO EXHAUST FAN ON ROOF.
- $\left\langle 7\right\rangle$ PROVIDE LOCKING COVER FOR T-STAT.
- 8 RETURN AIR GRILLE LOCATED UNDER RETURN AIR DUCTWORK.
- 9 HOLD DUCTWORK TIGHT TO BOTTOM OF STRUCTURE. (TYPICAL)
- PROVIDE A 36" WIDE X 6" HIGH LOUVERED SIDE WALL GRILLE CENTERED ABOVE DOOR. SEE ARCH'S PLANS FOR ELEVATIONS. BALANCE GRILLE TO 320

GENERAL NOTES:

11. CONTRACTOR TO COORDINATE

EQUIPMENT.

WITH ELECTRICAL AND DO NOT

12. ALL PIPING SHALL BE HELD TIGHT

TO BOTTOM OF STRUCTURE.

13. PROVIDE 4" DEEP SEAL TRAPS

WITH TRAP PRIMERS ON ALL

14. ALL WASTE PIPING TO BE SLOPED

AS REQUIRED BY CODE.

FLOOR DRAINS & FLOOR SINKS.

ROUTE PIPING OVER ELECTRICAL

- 1. ALL EXPOSED DUCTWORK OR DUCTWORK ABOVE GYP. CEILINGS SHALL BE HARD DUCTED.
- 2. USE YOUNG GEAR TYPE BALANCING REGULATORS ABOVE ALL GYP. BOARD CEILINGS.
- 3. ALL MEDIUM PRESSURE DUCTWORK SHALL BE HELD TIGHT TO BOTTOM OF STRUCTURE, OFFSET AND
- 4. OFFSET AND TRANSITION ALL DUCTWORK AND PIPING AS

TRANSITION AS REQUIRED.

- REQUIRED. 5. ALL VALVES SHALL BE LOCATED
- ABOVE ACCESSIBLE CEILINGS. 6. PROVIDE ACCESS PANELS AS

TRADES.


- REQUIRED. 7. CONTRACTOR TO COORDINATE ALL INSTALLATIONS WITH OTHER
- 8. CONTRACTOR TO COORDINATE ALL FINAL LOCATION OF T-STAT'S WITH OWNER AND ARCHITECT.
- CONTRACTOR TO PROVIDE AND INSTALL SOUND BOOTS ON ALL RETURN AIR GRILLES. BOOTS TO BE PAINTED FLAT BLACK.
- 10. CONTRACTOR TO COORDINATE GRILLES WITH REFLECTED CEILING

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S STORE

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OGDEN

BE OWNER DEPARTMENT (

	12-22-05	100% REVIEW
	12-16-05	REVIEW COMMENTS
	10-18-05	DESIGN DEVELOPMENT
MARK	DATE	DESCRIPTION

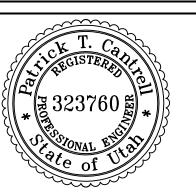PROJECT NUMBER: 05156.00 DRAWING FILE: See Drawing Stamp DRAWN BY: AJG CHECKED BY:


KAG


SHEET TITLE

Mechanical Floor Plan

M201

MECHANICAL FLOOR PLAN

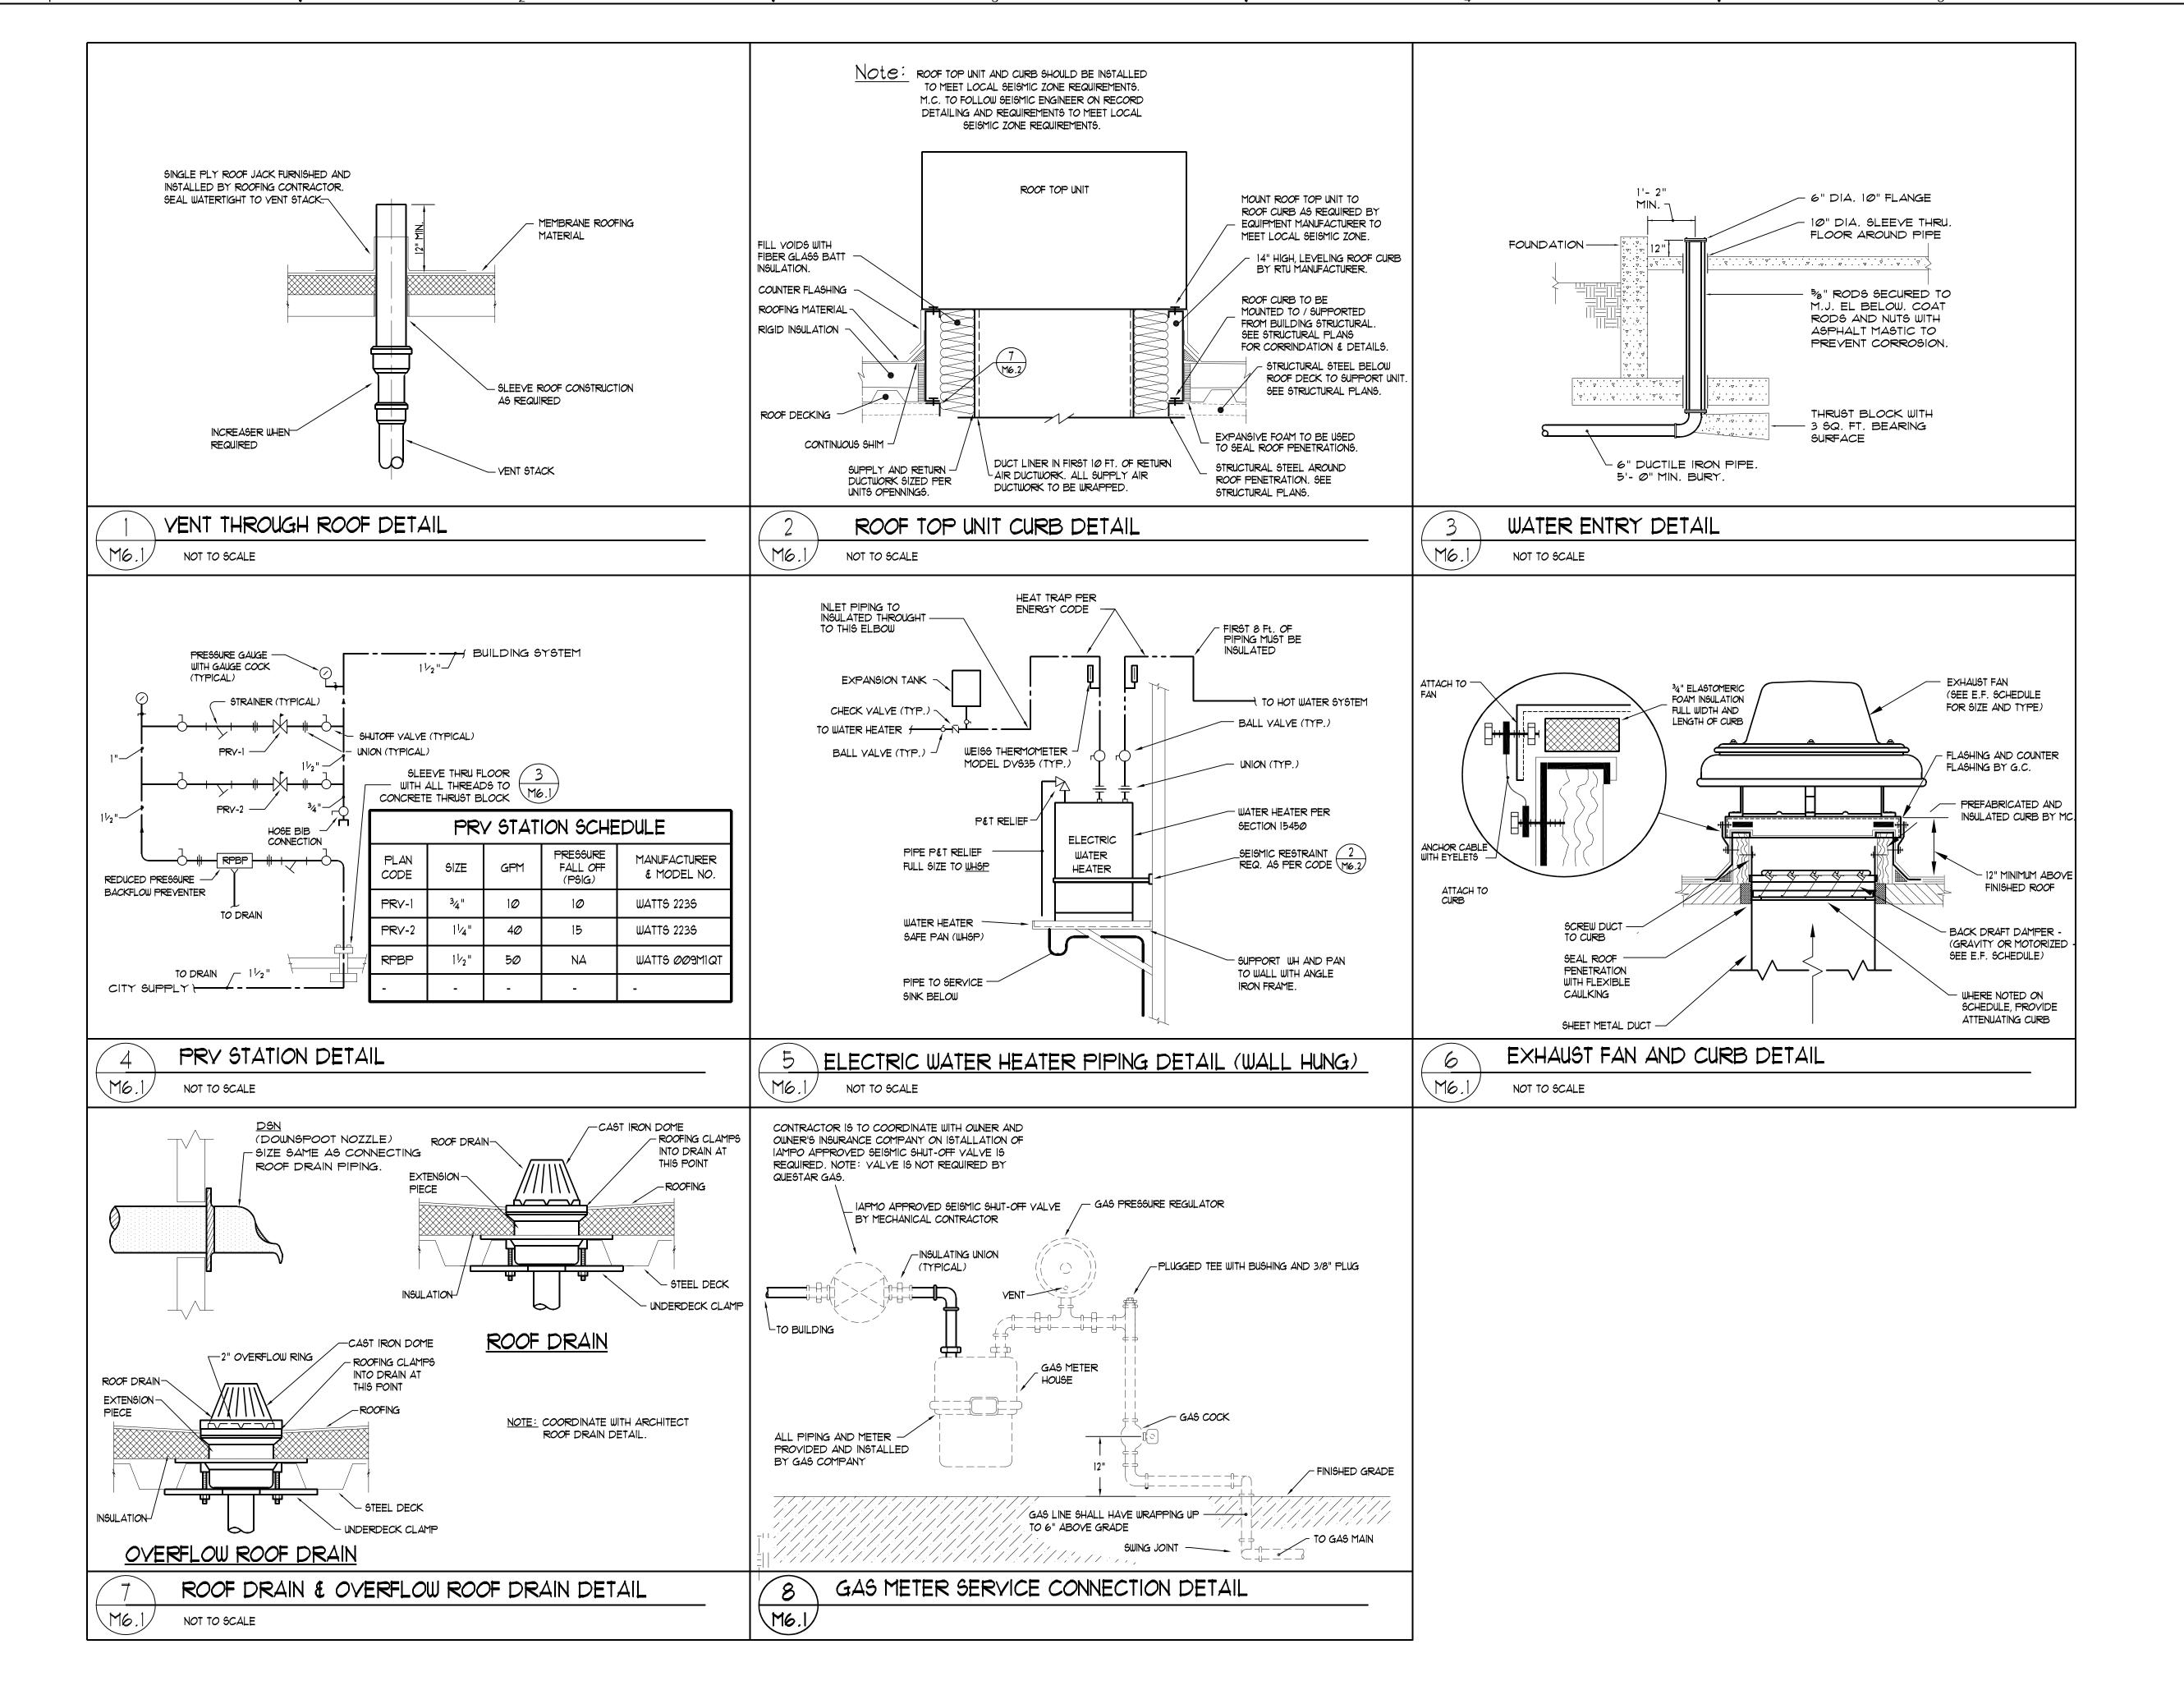

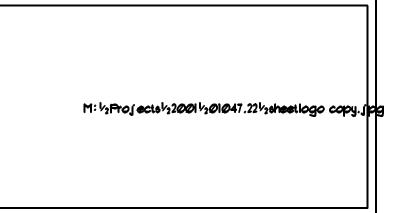


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OGDEN PATTERSON LIQUOR STORE # 2

OGDEN - UTAH

DEPARTMENT OF ALCHOLIC BEVERAGE CONTROL


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	12-16-05	REVIEW COMMENTS
	10-18-05	DESIGN DEVELOPMENT
MARK	DATE	DESCRIPTION

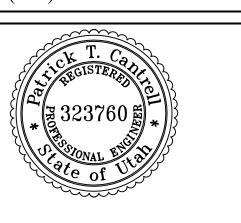
PROJECT NUMBER: 05156.00
DRAWING FILE: See Drawing Stamp
DRAWN BY: AJG
CHECKED BY: KAG

SHEET TITLE

Mechanical Details

M601

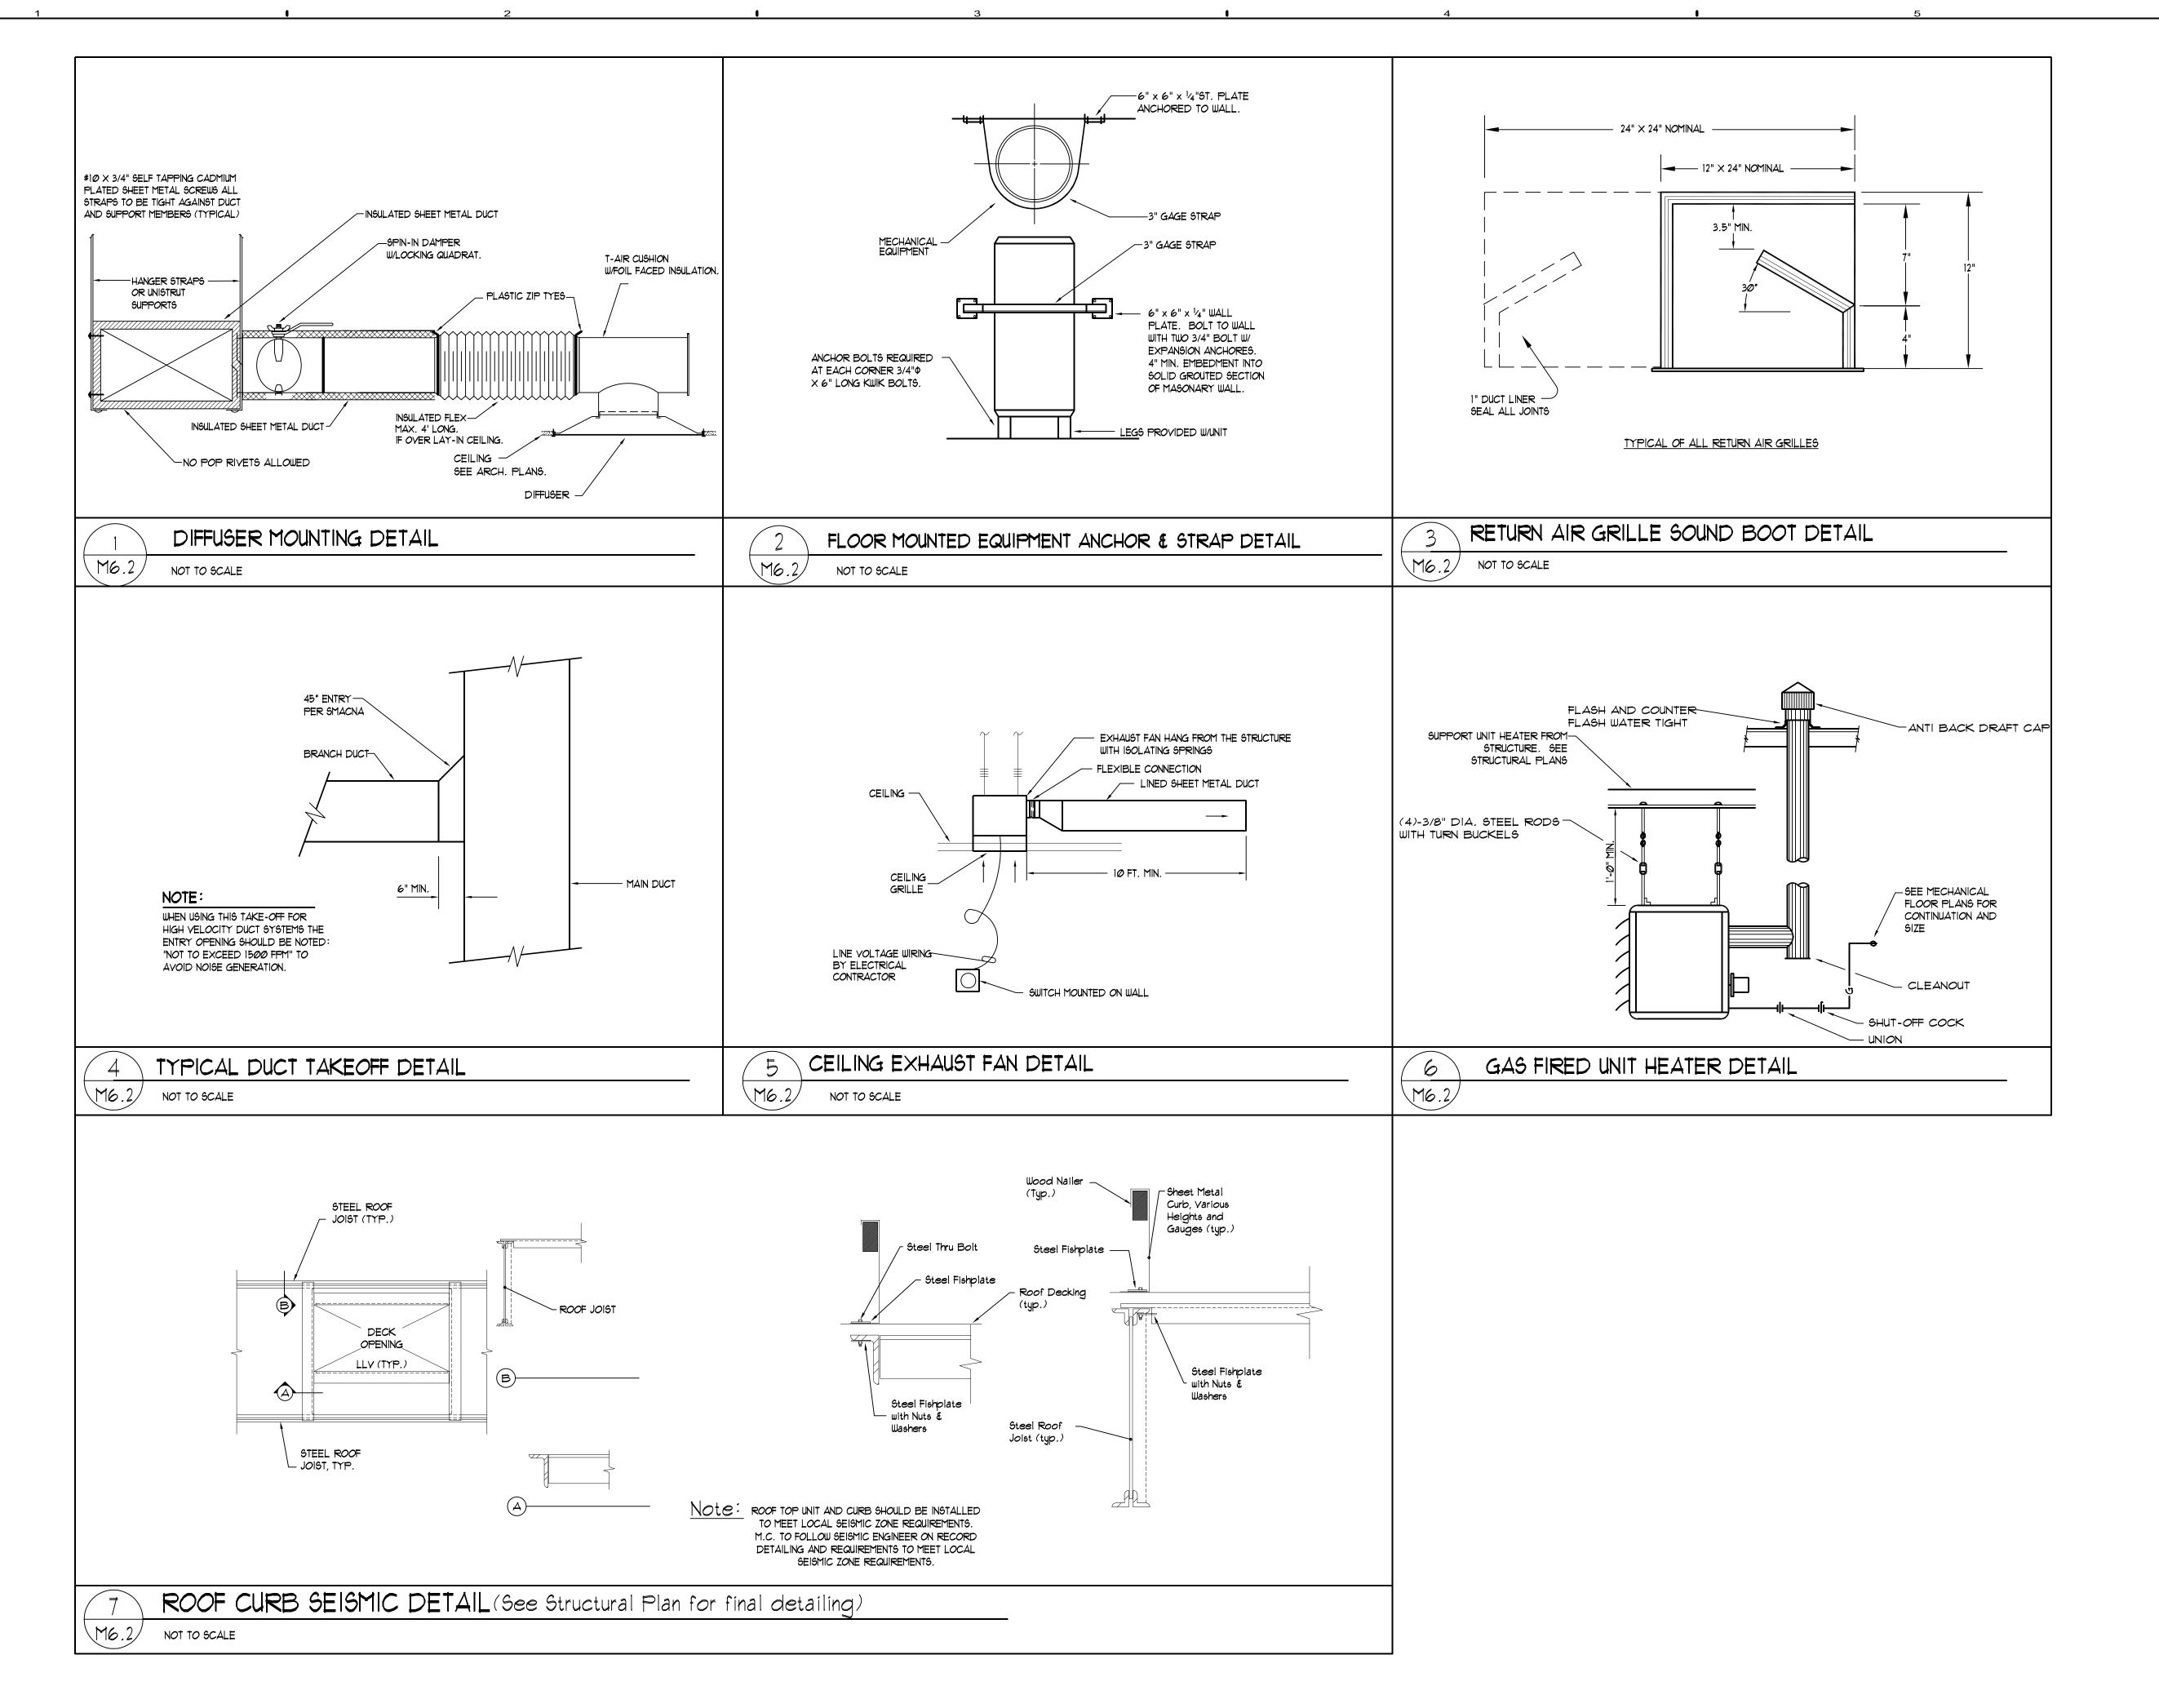

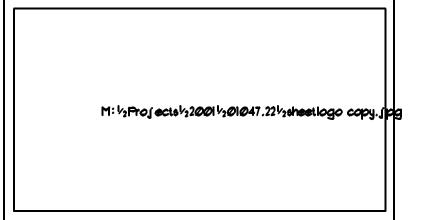


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OGDEN - UTAH

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DEPARTMENT OF ALCHOLIC BEVERAGE CONTROL


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	12-16-05	REVIEW COMMENTS
	10-18-05	DESIGN DEVELOPMENT
MARK	DATE	DESCRIPTION

PROJECT NUMBER: 05156.00
DRAWING FILE: See Drawing Stamp
DRAWN BY: AJG
CHECKED BY: KAG

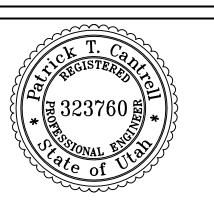
SHEET TITLE

Mechanical Details

M602

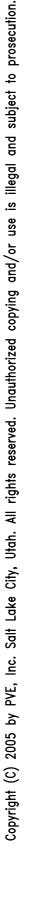



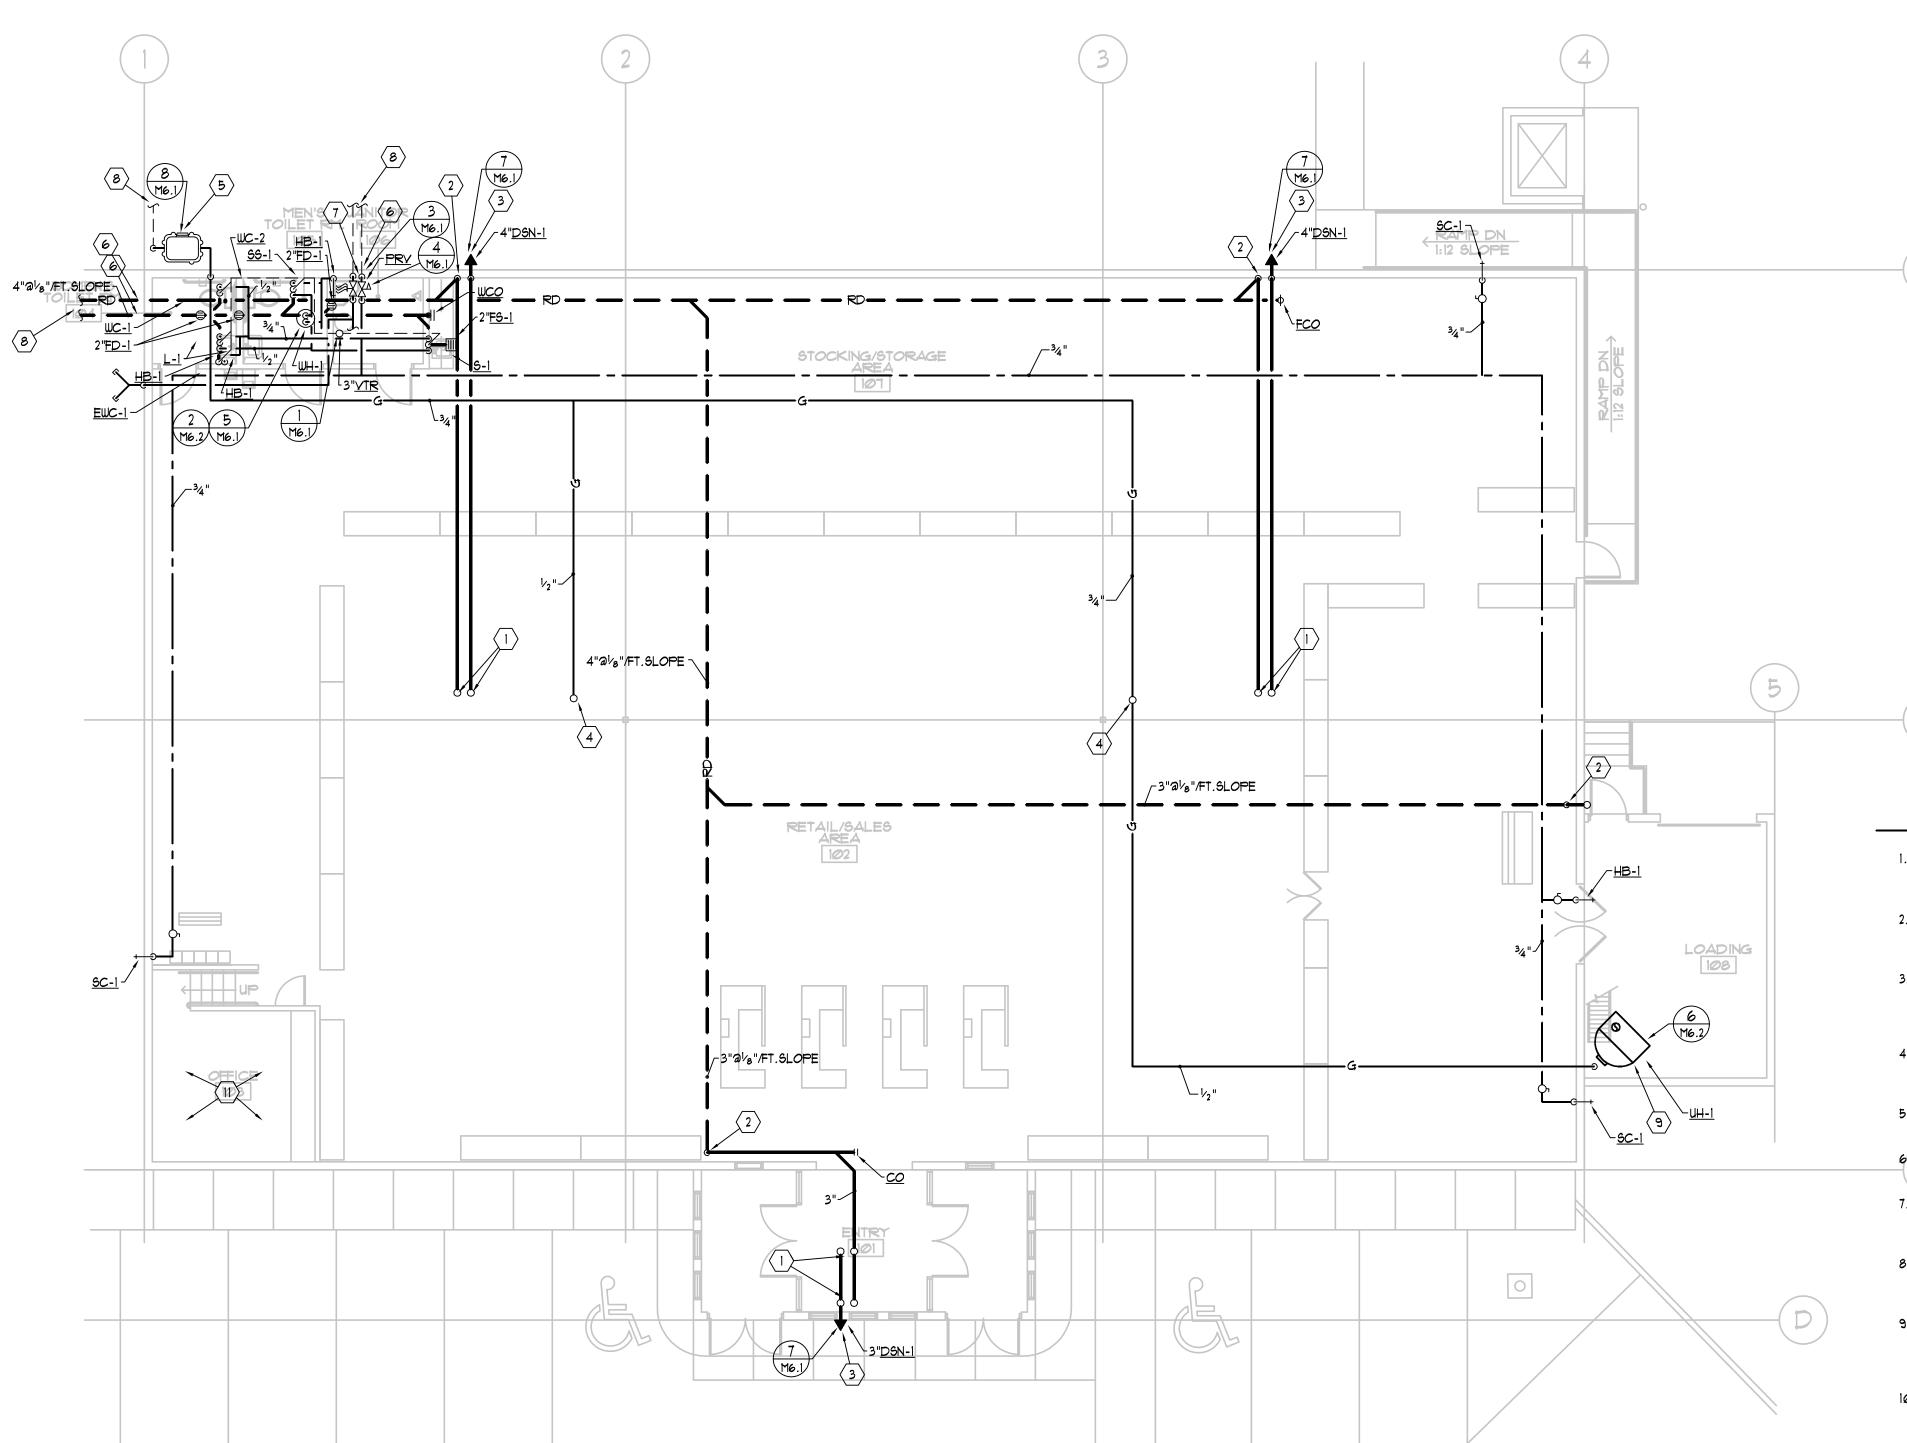

PLUMBING FLOOR PLAN

KEYED NOTES:

3" RISER TO ROOF AND OVERFLOW DRAINS ON ROOF

2 DROP PIPING TIGHT ALONG WALL TO ROUTE BELOW SLAB.

2 EXTEND DOWN SPOUTS OUT OF BUILDING UP HIGH. COORDINATE FINAL ELEVATIONS WITH ARCH'S PLANS.

4 V_2 " GAS RISER TO ROOF TOP UNIT. M.C. TO PROVIDE FINAL CONNECTIONS REQUIRED.

5 482 CFH (2 LB) GAS METER BY QUESTAR. GAS METER AND ENTRY BY QUESTAR.

M.C. TO FIELD VERIFY AND COORDINATE WITH ARCH'S AND CIVIL'S PLANS IN PROVIDING CODE REQUIRED COVERAGE OVER ALL PLUMBING LINES ENTERING & EXISTING THE BUILDING.

ALL FIRE PROTECTION PIPING TO BE SIZED BY F.P.C. MAIN FIRE WATER TO ENTER BUILDING AT THIS POINT. F.P.C. TO PROVIDE REQUIRED FIRE DEPARTMENT CONNECTION WITH HORN, LIGHTS AND STROBE ON EXTERIOR OF BUILDING.

8 M.C. TO EXTEND ALL UTILITIES 5FT.
OUTSIDE OF BUILDING.

9 PROVIDE FINAL CONNECTION TO UNIT HEATER.

M.C. TO PROVIDE WATER HAMMER
ARRESTORS ON ALL PIPING WITH QUICK
CLOSE VALVES. (TYPICAL)

F.P.C. TO PROVIDE FIRE PROTECTION IN MEZZ SPACE UNDER OFFICE.

GENERAL NOTES:

11. CONTRACTOR TO COORDINATE

EQUIPMENT.

WITH ELECTRICAL AND DO NOT ROUTE PIPING OVER ELECTRICAL

12. ALL PIPING SHALL BE HELD TIGHT

TO BOTTOM OF STRUCTURE.

13. PROVIDE 4" DEEP SEAL TRAPS

WITH TRAP PRIMERS ON ALL

14. ALL WASTE PIPING TO BE SLOPED

AS REQUIRED BY CODE.

FLOOR DRAINS & FLOOR SINKS.

 ALL EXPOSED DUCTWORK OR DUCTWORK ABOVE GYP. CEILINGS SHALL BE HARD DUCTED.

> USE YOUNG GEAR TYPE BALANCING REGULATORS ABOVE ALL GYP. BOARD CEILINGS.

3. ALL MEDIUM PRESSURE DUCTWORK SHALL BE HELD TIGHT TO BOTTOM OF STRUCTURE. OFFSET AND TRANSITION AS REQUIRED.

 OFFSET AND TRANSITION ALL DUCTWORK AND PIPING AS REQUIRED.

5. ALL VALVES SHALL BE LOCATED ABOVE ACCESSIBLE CEILINGS.

6. PROVIDE ACCESS PANELS AS REQUIRED.

CONTRACTOR TO COORDINATE ALL INSTALLATIONS WITH OTHER TRADES.

 CONTRACTOR TO COORDINATE ALL FINAL LOCATION OF T-STAT'S WITH OWNER AND ARCHITECT.

CONTRACTOR TO PROVIDE AND INSTALL SOUND BOOTS ON ALL RETURN AIR GRILLES. BOOTS TO BE PAINTED FLAT BLACK.

10. CONTRACTOR TO COORDINATE
GRILLES WITH REFLECTED CEILING

Phone: (801) 359-3158 Fax: (801) 521-4114

T. Carrier Storage of Transfer of Transfer

90 South 400 West, Suite 340

Salt Lake City UT, 84101

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CONSULTANTS

OGDEN PATTERSON LIQUOR STORE # 24
OGDEN - UTAH

BE

OGDEN - UTAH		OWNER DEPARTMENT
	T	
	12-22-05	100% REVIEW
	12-16-05	REVIEW COMMENTS
	10-18-05	DESIGN DEVELOPMENT
MARK	DATE	DESCRIPTION

PROJECT NUMBER: 05156.00
DRAWING FILE: See Drawing Stamp
DRAWN BY: AJG
CHECKED BY: KAG

SHEET TITLE


Plumbing Floor Plan

P201

GENERAL NOTES

- DO NOT SCALE DRAWINGS VERIFY DIMENSIONS IN FIELD PRIOR TO MAKING ANY ROUGH-INS.
- FINAL CONNECTIONS TO EQUIPMENT SHALL BE MADE AS PER MANUFACTURERS URITTEN NOTRUCTIONS AND APPROVED WRING DIAGRAMS AND DETAILS. IT SHALL BE THE CONTRACTORS RESPONSIBILITY TO PROVIDE ALL MATERIALS AND EQUIPMENT COMPATIBLE WITH EQUIPMENT ACTUALLY SUPPLIED.
- CONSULT ARCHITECTS REFLECTED CEILING PLANS FOR EXACT LOCATIONS OF LIGHTING FIXTURES, SPEAKERS, SMOKE DETECTORS ETC.
- ELECTRICAL CONTRACTOR SHALL MEET WITH THE CEILING AND MECHANICAL CONTRACTORS TO COORDINATE LOCATIONS, CLEARANCES, CEILING TYPES AND ROUGH-IN REGUIREMENTS OF ALL LIGHTING FIXTURES PRIOR TO DUCT, PIPING AND CEILING INSTALLATIONS.
- ALL EMPTY RACEWAY SYSTEMS SHALL HAVE A 200LB RATED PULL CORD INSTALLED AND SHALL BE IDENTIFIED AT EACH JUNCTION, PULL AND TERMINATION POINT, USING PERMANANT MARKER IN THE BOX. ID SHALL INDICATE INTENDED USE OF CONDUIT, ORIGINATION AND TERMINATION POINTS OF EACH INDIVIDUAL CONDUIT.
- ALL PENETRATIONS OF FIRE RATED FLOORS, CEILING AND WALLS SHALL BE SEALED WITH APPROVED AND RATED FIRE STOP MATERIAL TO MAINTAIN FIRE RATING OF
- ELECTRICAL BOXES SHALL NOT BE LOCATED IN MASONRY OR CONCRETE COLUMNS, BOND BEAMS OR GROUTED CELLS OF MASONRY WALLS ADJACENT TO OPENINGS WITHOUT COORDINATION WITH THE MASONRY CONTRACTOR.
- 3. IT IS THE INTENT OF THESE DRAWINGS AND SPECIFICATIONS TO ESTABLISH A A STANDARD OF QUALITY. THE ENGINEER RESERVES THE RIGHT TO VERBALLY APPROVE METHODS AND MATERIALS NOT REFLECTED HEREIN.
- CONTRACTOR SHALL REVIEW ARCHITECTURAL, STRUCTURAL, MECHANICAL, PLUMBING AND OTHER DRAWINGS PRIOR TO BID.
- 10. WORK SHALL BE PERFORMED IN A PROFESSIONAL WORKMANLIKE MANNER TO THE SATISFACTION OF THE ARCHITECT AND ENGINEER.
- WORK, MATERIALS AND EQUIPMENT SHALL CONFORM TO THE LATEST EDITIONS OF
- LOCAL, STATE AND NATIONAL CODES, STANDARDS AND ORDINANCES. CONTRACTOR SHALL SECURE AND PAY FOR ALL NECESSARY BUILDING PERMITS
- THE CONTRACTOR SHALL GUARANTEE THE INSTALLATION AGAINST DEFECTS IN MATERIALS AND WORKMANSHIP, WHICH MAY OCCUR UNDER NORMAL USAGE FOR A PERIOD OF ONE YEAR AFTER SUBSTANTIAL COMPLETION. DEFECTS SHALL BE PROMPTLY CORRECTED.
- 14. PROVIDE RECORD DRAWINGS IN ACCORDANCE WITH THE PROJECT SPECIFICATIONS. 15. VERIFY EXACT LOCATION OF EQUIPMENT TO BE FURNISHED BY OTHERS PRIOR
- . ELECTRICAL CONTRACTOR SHALL VERIFY ALL EQUIPMENT DIMENSIONS AND LOCATIONS BEFORE BEGINNING ROUGH-INS, CONSULT CONTRACT DOCUMENT DRAWINGS AND SHOP DRAWINGS TO VERIFY ALL CODE AND MAINTENANCE
- REGUIRED CLEARANCES ARE MAINTAINED. CONTRACTOR SHALL VERIFY ACTUAL ELECTRICAL LOADS OF EACH PIECE OF EQUIPMENT REQUIRING POWER, BRING ANY DESCREPANCIES TO THE ATTENTION
- OF THE PROJECT ENGINEER. . SYSTEMS SHALL BE TESTED FOR PROPER OPERATION. IF TESTS RESULT IN DEFECT OR IMPROPER OPERATION THE CONTRACTOR SHALL MAKE ANY CORRECTIONS NECESSARY AT NO ADDITIONAL COSTS TO THE OWNER.
- 19. WIRE SHALL BE COPPER 75° C RATED FOR GENERAL USE. FOR HID FIXTURES AND WIRING WITHIN 3" OF FLUORESCENT BALLAST SHALL BE COPPER, MINIMUM 30" C RATED. CONDUCTOR SIZES INDICATED ARE FOR INSTALLATION IN A MAXIMUM 30" C AMBIENT TEMPERATURE ENVIROMENT. CONDUCTOR AMPACITY SHALL BE DERATED FOR HIGHER AMBIENT INSTALLATIONS.
- 20. SPLICES IN EXTERIOR FULLBOXES AND MANHOLES SHALL BE MADE WATERPROOF USING "SCOTCAST" SPLICE KIT OR APPROVED EQUAL. SEAL ENDS OF CONDUITS AND DUCTS ENTERING BOXES WITH "DUCTSEAL" OR EQUAL.
- SUBMIT SHOP DRAWINGS IN ACCORDANCE WITH SPECIFICATIONS BOUND IN A THREE RING BINDER, INDEXED IN A NEAT AND ORDERLY MANNER WITH TYPE AND MODEL NUMBERS INDICATED. SUBMITTALS SHALL INCLUDE BUT NOT LIMITED TO: LIGHTING FIXTURES, LAMPS, WIRING DEVICES, OCCUPANCY SENSORS, CONTACTORS, TIME CLOCKS, PHOTOCELLS, RELAYS, SWITCHBOARDS, PANELBOARDS, MOTOR CONTROL CENTERS, SAFETY SWITCHES, MOTOR STARTERS, OVERCURRENT PROTECTION DEVICES, TRANSFORMERS, CONDUCTORS OVER 600 VOLTS AND ALL SPECIAL SYSTEMS SUCH AS FIRE ALARM, LIGHTING CONTROLS, SECURITY SYSTEMS,
- 22. VERIFY EXACT LOCATIONS OF ALL NEW AND EXISTING UNDERGROUND SITE UTILITIES, PIPING AND RACEWAY SYSTEMS PRIOR TO TRENCHING. PROVIDE NECESSARY TRENCHING, BACKFILL EXCAVATION, SUPPORTS, SERVICE FEEDERS, (CONDUIT AND/OR WIRE), PULL BOXES, TRANSPORMER PADS, SAW CUTTING AND PATCHING, CONCRETE PAVING ETC, REQUIRED. BACKFILL TRENCHES TO 90% COMPACTION AND PATCHING TO MATCH EXISTING. CONTRACTOR SHALL OBTAIN AND VERIFY EXACT UTILITY COMPANY DRAWINGS AND REQUIREMENTS FOR ALL SITE UTILITIES. ELECTRICAL CONTRACTOR SHALL ALSO CONTRACTOR SHALL SITE UTILITIES. ELECTRICAL CONTRACTOR SHALL ALSO CONTRACTOR SHALL ALSO CONTRACTORS. UTILITIES WITH THE CIVIL AND MECHANICAL ENGINEERS AND CONTRACTORS.
- PULLBOXES, CABINETS, ETC. MOUNTED ON THE EXTERIOR OF THE BUILDING AT GRADE LEVEL, SHALL BE WEATHERPROOF TYPE WITH HINGED GASKETED LOCKABLE COVERS SECURED WITH TAMPERPROOF SCREWS.
- 24. CONTROL OUTDOOR LIGHTING WITH CONTACTOR & 24/7 TIME CLOCK WITH RESERVE POWER AND PHOTO CELL NEAR ROOF.

	LIGHTING FIXTURE SCHEDULE							
FIXTURE						FIX		
TYPE	MANUFACTURE	CATALOG NUMBER	DESCRIPTION	LAMPS	QTY	WATTS	MTG	VOLTS
A	METALUX	2RDI-254T5-RP- 12Ø-EBTI	REC. DIRECT/INDIRECT FLUORESCENT FIXTURE W/ HO LAMPS	F54 T5HO 5P35	2	115	LAY-IN	120
AE	METALUX	2RDI-254T5-RP- 12Ø-EBTI-EM	REC. DIRECT/INDIRECT FLUORESCENT FIXTURE W/ HO LAMPS W/EMERGENCY	F54 T5HO 5P35	2	115	LAY-IN	120
В	METALUX	2GC8-332Al25-l2Ø- EB8l	LAY-IN 3 LAMP LENSED FLUORESCENT TROFFER	F32 T8 SP35	3	95	LAY-IN	120
BE	METALUX	2GC8-332Al25-l2Ø- EB8I-EM	LAY-IN 3 LAMP LENSED FLUORESCENT TROFFER W/ EMERGENCY BATT, PACK	F32 T8 SP35	3	95	LAY-IN	120
С	METALUX	BI-232-12Ø-EB8I	WALL MOUNTED 4' 2LAMP FLUORESCENT FIXTURE	F32 T8 5P35	2	66	SURF WAL	120
Ď	METALUX	WB-232A-12Ø-EB81	SURFACE MOUNT 2LAMP FLUORESCENT WRAP AROUND FIXTURE	F32 T8 SP35	2	66	SURF	120
E	SURE LITE	CUIHD	WALL MOUNTED EMERGENCY BATTERY PACK	L/W FIXTURE	2	50	SURF	120
F	METALUX	9T-DI-232-12Ø- EB8I	8' 2LAMP INDUSTRIAL FLUORESCENT FIXTURE	F32 T8 9P35	4	110	SUSP	120
G	PORTFOLIO	C7042E-E-7000- LI-TRM7P	WALL MOUNT INDIRECT HID	175 MH	1	190	SURF.	120
н	HALO	L652P WITH LZRP FIXTURES 16-TØTAL	SINGLE CIRCUIT LIGHT TRACK W/FIXTURES	75W PAR3	1	75	TRACK	120
×I	SURE LITE	C×717Ø-G-9D	LED EXIT SIGN WITH BLACK BODY & GREEN LETTERS	C/W FIXTURE	•	4	SURF	120
OA	INVUE	ENVIOOMH-120-MB- FTP-GM-LG	SURFACE MOUNTED HID ACCENT FIXTURE	(1) 100W MH	1	110	SURF	120
<i>0</i> B	LUMARK	MHWK175120	175W METAL HALIDE WALL PACK	175W MH	1	185	SURF	120
oc	INVUE	AEN400MH208-35 GM-FF-VA1055-GM SSX4A25SGM MIG	POLE MOUNTED 400W METAL HALIDE AREA LIGHTING FIXTURE	400W MH	1	460	POLE& BASE	208

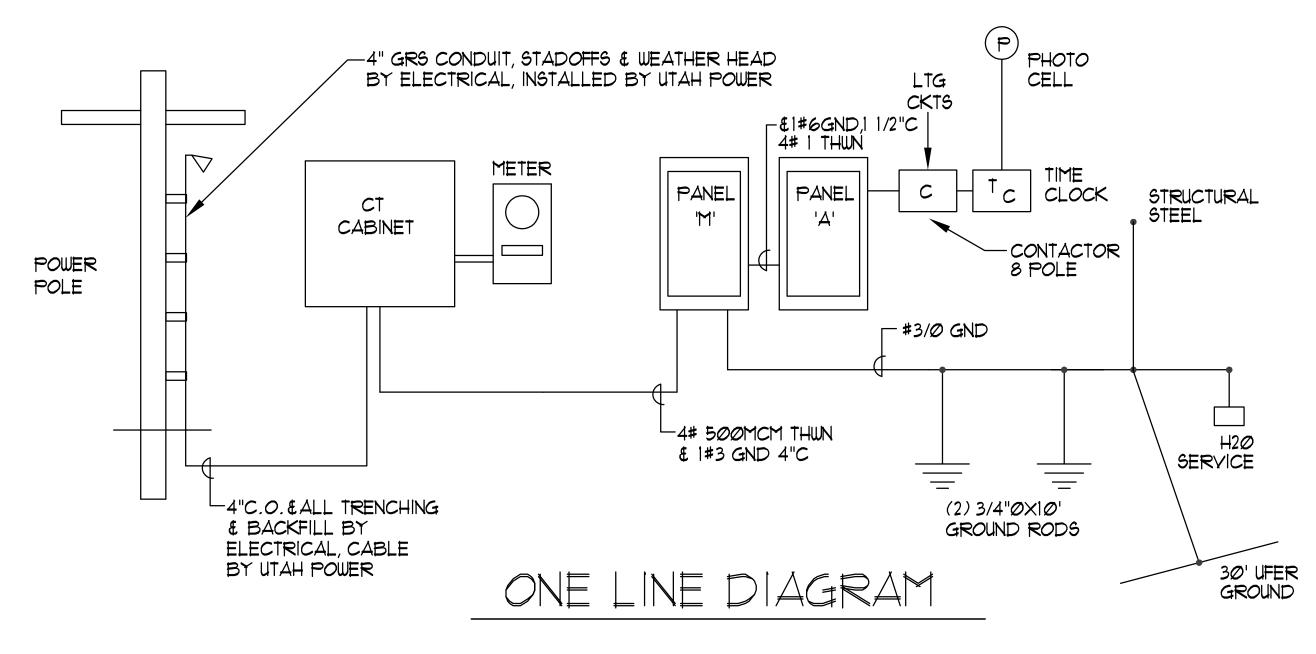


SYNDOL DESCRIPTION SYNDOL DESCRIPTION ONE CRECUIT, TUD WIRE NOTE RIN TO PANEL ONE CRECUIT, TUD WIRE COMPON NEUTRAL HOME RIN CONDUIT RIN COMPON NEUTRAL HOME CERNIS CERNS LIGHT FIXTURE CONDUIT RIN COMPON NEUTRAL HOME CERNIS CERNS LIGHT FIXTURE CERNS CERNS LIGHT FIXTURE CERNS CERNS CONDUIT RIN COMPON NEUTRAL HOME RIN CERNS CONDUIT RIN COMPON NEUTRAL HOME RECEPTACLE CONDUIT RIN COMPON NEUTRAL HOME RIN JAYO TO TEL EQUIP BOARD CONDUIT RIN COMPON NEUTRAL POWER RIN COMPON NEUTRAL HOME RIN RIN COMPON NEUTRAL HOME RIN	ELE	CTRICAL SYMBOL	SCH	EDULE
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### 2 CIRCUIT, 3 UNISE, COPPION NEUTRAL HOPE RAN SIRRUIT, 4 UNISE, COPPION NEUTRAL HOPE RAN CONDUIT RAN CONCEALED N WALL OR CEILING CONDUIT DOWN CONDUIT TOTUS LOCATION CEILING AS NOTED CEILING CEILING AS NOTED CEILING CEILING CEILING CONDUIT TOTUS LIGHT CEILING CEILING CEILING CEILING CONDUIT TOTUS LIGHT CEILING	SYMBOL	DESCRIPTION		NOTES
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## PAURE LIAT SUITCH ## POUR LIAT SUITCH ## BELECTRIC MATER COOLER RECEPTACLE ## ISOLATED GROUND RECEPTACLE ## ISOLATED GROUND RECEPTACLE ## POUR LIAT INTERRIPTER DUPLEX RECEPTACLE ## POUR LIAT LIAT LIAT LIAT LIAT LIAT LIAT LIAT				
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### WEATHERPROOF RECEPTACLE ### SOLATED GROUND RECEPTACLE ### SOLATED GROUND RECEPTACLE ### SOLATED GROUND RECEPTACLE ### COURPLEX RECEPTACLE ### COURPLEX RECEPTACLE ### COURPLEX RECEPTACLE ### COURPLEX RECEPTACLE ### SOLATED GROUND RECEPTACLE ### SOLATED GROUND RECEPTACLE ### COURPLEX RECEPTACLE ### SOLATED GROUND RECEPTACLE ### SOLATED GROUND RECEPTACLE ### SOLATED ### SOLATED GROUND RECEPTACLE ### SOLATED ### SOLATED GROUND RECEPTACLE ### SOLATED				AEE DETAIL
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MANUAL STARTER THERMAL OVERLOAD SWITCH WIPLOT LIGHT 4'-0" PANEL BOARD TELEPHONE TERMINAL BOARD F FIRE ALARM MANUAL STATION H FIRE ALARM SIGNAL SPEAKER/STROBE © 9 SMOKE DETECTOR CEILING © D DUCT SMOKE DETECTOR MTD. IN DUCT © H HEAT DETECTOR CEILING R FAN SHUT DOWN RELAY AT RTU AT RTU AT RTU AT RTU AT RTU AT RTU DISCONNECT SWITCH DISCONNECT SWITCH DOOR POSITION INDICATOR SWITCH "DPIS" TOP OF DOOR JAMES FLOOR DOOR SENSOR SWITCH FLOOR				
PANEL BOARD TOP AT 46'-0" TELEPHONE TERMINAL BOARD F FIRE ALARM MANUAL STATION H FIRE ALARM SIGNAL SPEAKER/STROBE (6'-8" (6) SMOKE DETECTOR (CEILING) DUCT SMOKE DETECTOR (CEILING) HEAT DETECTOR (CEILING) AT RTU AT RTU AT RTU AT RTU LIGHT FIXTURE (LETTER DESIGNATES TYPE) COMPANION OF HEAD DOOR CONTROLLER PUSED DISCONNECT SUITCH DISCONNECT SUITCH SECURITY SYSTEM MOTION SENSOR CEILING DOOR POSITION INDICATOR SUITCH "DPIS" FLOOR			EQUIP.	
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FIRE ALARM MANUAL STATION H FIRE ALARM SIGNAL SPEAKER/STROBE 6'-8" S SMOKE DETECTOR CEILING D DUCT SMOKE DETECTOR MID. IN DUCT HEAT DETECTOR CEILING R FAN SHUT DOWN RELAY AT RTU AT RTU AT RTU AT RTU LIGHT FIXTURE (LETTER DESIGNATES TYPE) COVER HEAD DOOR CONTROLLER OVER HEAD DOOR CONTROLLER PUSCONNECT SWITCH DISCONNECT SWITCH SECURITY SYSTEM MOTION SENSOR GLASS BREAKAGE SENSOR CEILING DOOR POSITION INDICATOR SWITCH FLOOR FLOOR FLOOR FLOOR FLOOR				
FIRE ALARM SIGNAL SPEAKER/STROBE FIRE ALARM SIGNAL SPEAKER/STROBE 16'-8"				
OS SMOKE DETECTOR OD DUCT SMOKE DETECTOR OH HEAT DETECTOR EN FAN SHUT DOWN RELAY AT RTU 842 ARCHITECTURAL ROOM NUMBER ALIGHT FIXTURE (LETTER DESIGNATES TYPE) EQUIPMENT NUMBER OVER HEAD DOOR CONTROLLER PUSED DISCONNECT SWITCH DISCONNECT SWITCH OS SECURITY SYSTEM MOTION SENSOR CEILING GEO GLASS BREAKAGE SENSOR DOOR POSITION INDICATOR SWITCH "DPIS" FLOOR FLOOR CEILING FLOOR FLOOR FLOOR		FIRE ALARM MANUAL STATION		
○ D DUCT SMOKE DETECTOR MTD. IN DUCT ○ H HEAT DETECTOR CEILING R FAN SHUT DOWN RELAY AT RTU 842 ARCHITECTURAL ROOM NUMBER AT RTU A LIGHT FIXTURE (LETTER DESIGNATES TYPE) EQUIPMENT NUMBER CEUIPMENT NUMBER ● OVER HEAD DOOR CONTROLLER PUSED DISCONNECT SWITCH □ J DISCONNECT SWITCH DISCONNECT SWITCH ★ SECURITY SYSTEM MOTION SENSOR CEILING ★ GLASS BREAKAGE SENSOR CEILING ★ DOOR POSITION INDICATOR SWITCH "DPIS" TOP OF DOOR JAMB ★ FLOOR DOOR SENSOR SWITCH FLOOR		FIRE ALARM SIGNAL SPEAKER/STROBE		
OH HEAT DETECTOR R FAN SHUT DOWN RELAY AT RTU 842 ARCHITECTURAL ROOM NUMBER LIGHT FIXTURE (LETTER DESIGNATES TYPE) EQUIPMENT NUMBER OVER HEAD DOOR CONTROLLER PUSED DISCONNECT SWITCH DISCONNECT SWITCH DISCONNECT SWITCH SECURITY SYSTEM MOTION SENSOR CEILING GB GLASS BREAKAGE SENSOR DOOR POSITION INDICATOR SWITCH "DPIS" FLOOR FLOOR FLOOR FLOOR		SMOKE DETECTOR	CEILING	
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LIGHT FIXTURE (LETTER DESIGNATES TYPE) EQUIPMENT NUMBER OVER HEAD DOOR CONTROLLER PUSED DISCONNECT SWITCH DISCONNECT SWITCH SECURITY SYSTEM MOTION SENSOR CEILING GB GLASS BREAKAGE SENSOR DOOR POSITION INDICATOR SWITCH "DPIS" FLOOR FLOOR		FAN SHUT DOWN RELAY	AT RTU	
EQUIPMENT NUMBER OVER HEAD DOOR CONTROLLER PUSED DISCONNECT SWITCH DISCONNECT SWITCH SECURITY SYSTEM MOTION SENSOR GELASS BREAKAGE SENSOR CEILING TOP OF DOOR POSITION INDICATOR SWITCH "DPIS" FLOOR DOOR SENSOR SWITCH FLOOR	842	Architectural room number		
OVER HEAD DOOR CONTROLLER PUSED DISCONNECT SWITCH DISCONNECT SWITCH SECURITY SYSTEM MOTION SENSOR CEILING GB GLASS BREAKAGE SENSOR CEILING TOP OF DOOR POSITION INDICATOR SWITCH "DPIS" FLOOR FLOOR FLOOR		LIGHT FIXTURE (LETTER DESIGNATES TYPE)		
PUSED DISCONNECT SWITCH DISCONNECT SWITCH SECURITY SYSTEM MOTION SENSOR CEILING GB GLASS BREAKAGE SENSOR CEILING CEILING TOP OF DOOR POSITION INDICATOR SWITCH "DPIS" FLOOR DOOR SENSOR SWITCH FLOOR	(EG) 34	EQUIPMENT NUMBER		
DISCONNECT SWITCH SECURITY SYSTEM MOTION SENSOR CEILING GB GLASS BREAKAGE SENSOR CEILING CEILING TOP OF DOOR POSITION INDICATOR SWITCH "DPIS" FLOOR FLOOR FLOOR	•••	OVER HEAD DOOR CONTROLLER		
SECURITY SYSTEM MOTION SENSOR GELASS BREAKAGE SENSOR CEILING CEILING CEILING TOP OF DOOR POSITION INDICATOR SWITCH "DPIS" FLOOR DOOR SENSOR SWITCH FLOOR	ď	PUSED DISCONNECT SWITCH		
GE GLASS BREAKAGE SENSOR CEILING DOOR POSITION INDICATOR SWITCH "DPIS" FLOOR DOOR SENSOR SWITCH FLOOR		DISCONNECT SWITCH		
DOOR POSITION INDICATOR SWITCH "DPIS" TOP OF DOOR JAMB FLOOR DOOR SENSOR SWITCH FLOOR	<u>(f)</u>	SECURITY SYSTEM MOTION SENSOR	CEILING	
F FLOOR DOOR SENSOR SWITCH FLOOR	GB	glass breakage sensor		
	•	DOOR POSITION INDICATOR SWITCH "DPIS"		
CCTV CAMERA CEILING	∳ F	FLOOR DOOR SENSOR SWITCH	FLOOR	
		CCTV CAMERA	CEILING	



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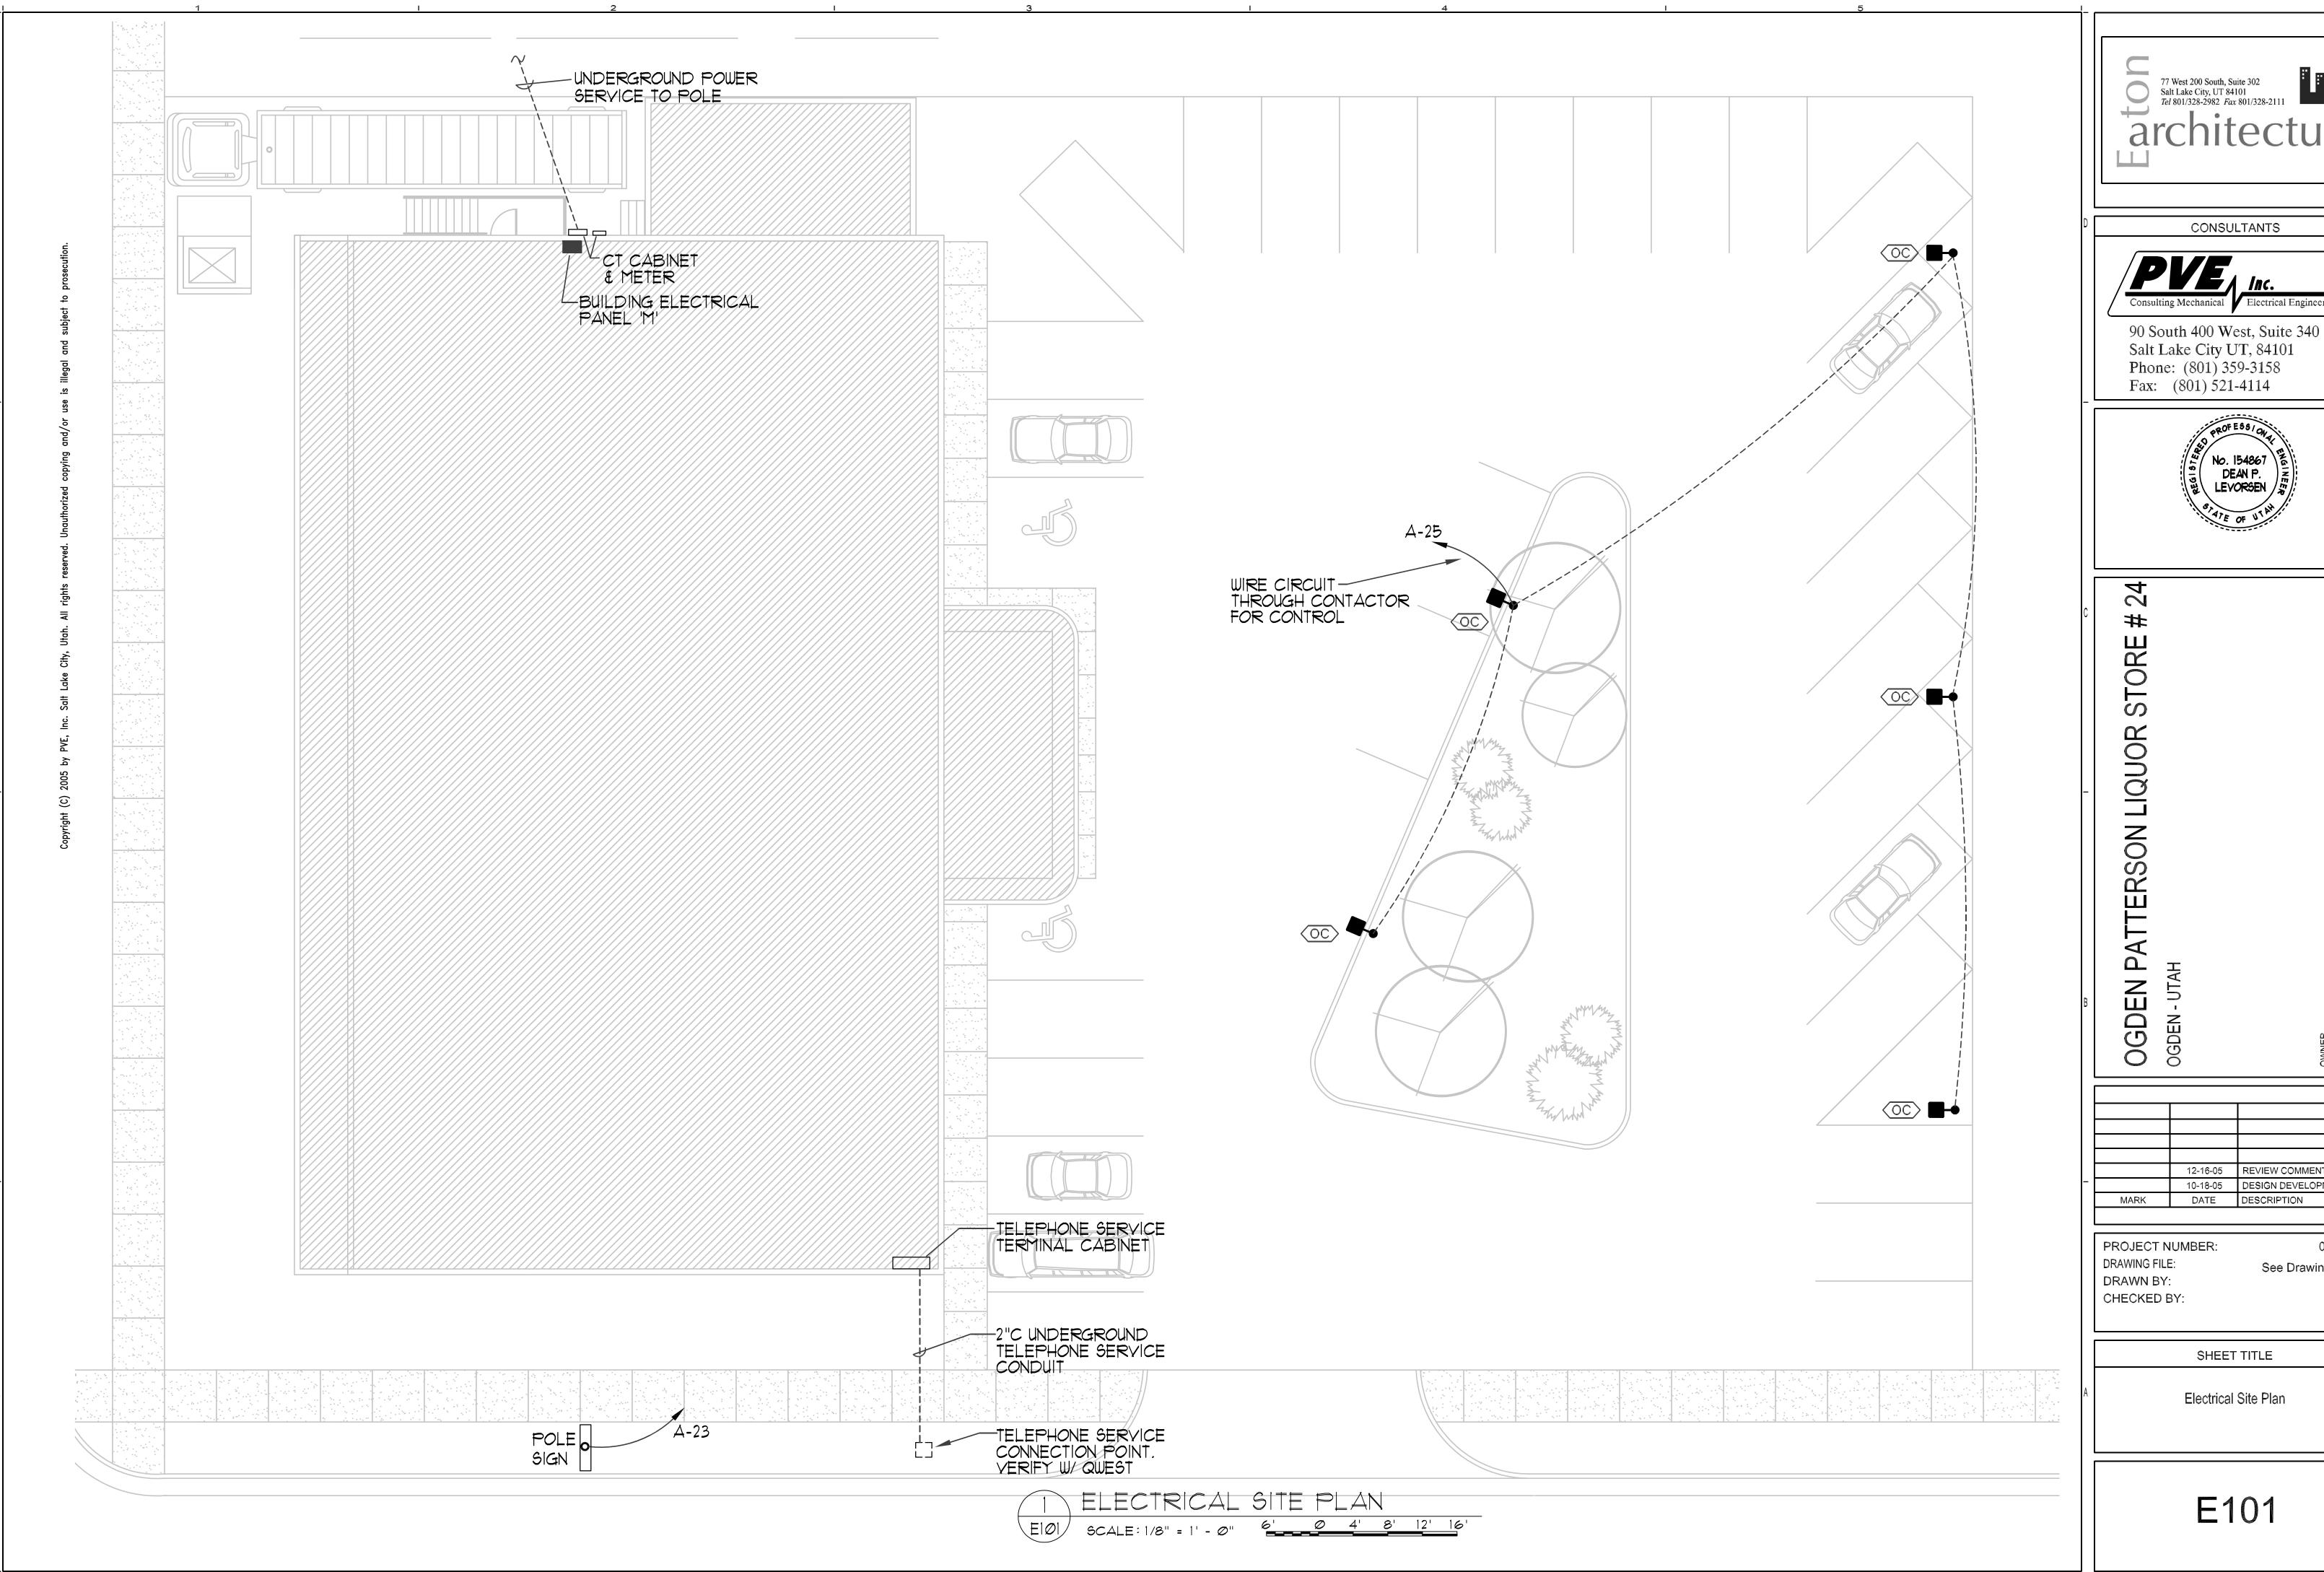
C \circ ALCOHOL TERS(OWNER DEPARTMENT (OGDEN

		12-16-05	REVIEW COMMENTS
_		10-18-05	DESIGN DEVELOPMENT
	MARK	DATE	DESCRIPTION

PROJECT NUMBER: 05156.01 DRAWING FILE: See Drawing Stamp DRAWN BY: CHECKED BY: RKR

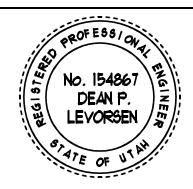SHEET TITLE

Electrical Notes, Symbols and Schedules







OWNER

DEPARTMENT OF ALCOHOL

	12-16-05	REVIEW COMMENTS
	10-18-05	DESIGN DEVELOPMENT
MARK	DATE	DESCRIPTION

05156.01 See Drawing Stamp RKR


KEYED NOTES

- FLUORESCENT FIXTURE LOCATED UNDER RAISED OFFICE.
- $\left\langle 2\right\rangle$ WIRE CIRCUIT THROUGH CONTACTOR.
- THE TYPE B & BE LIGHTING FIXTURES

 (48) TOTAL IN THE RETAIL AREA ARE BASE BID.

 THE LIGHTING FIXTURES ARE TO CHANGE

 TO TYPES A&AE UNDER ADD ALTERNATE #3.

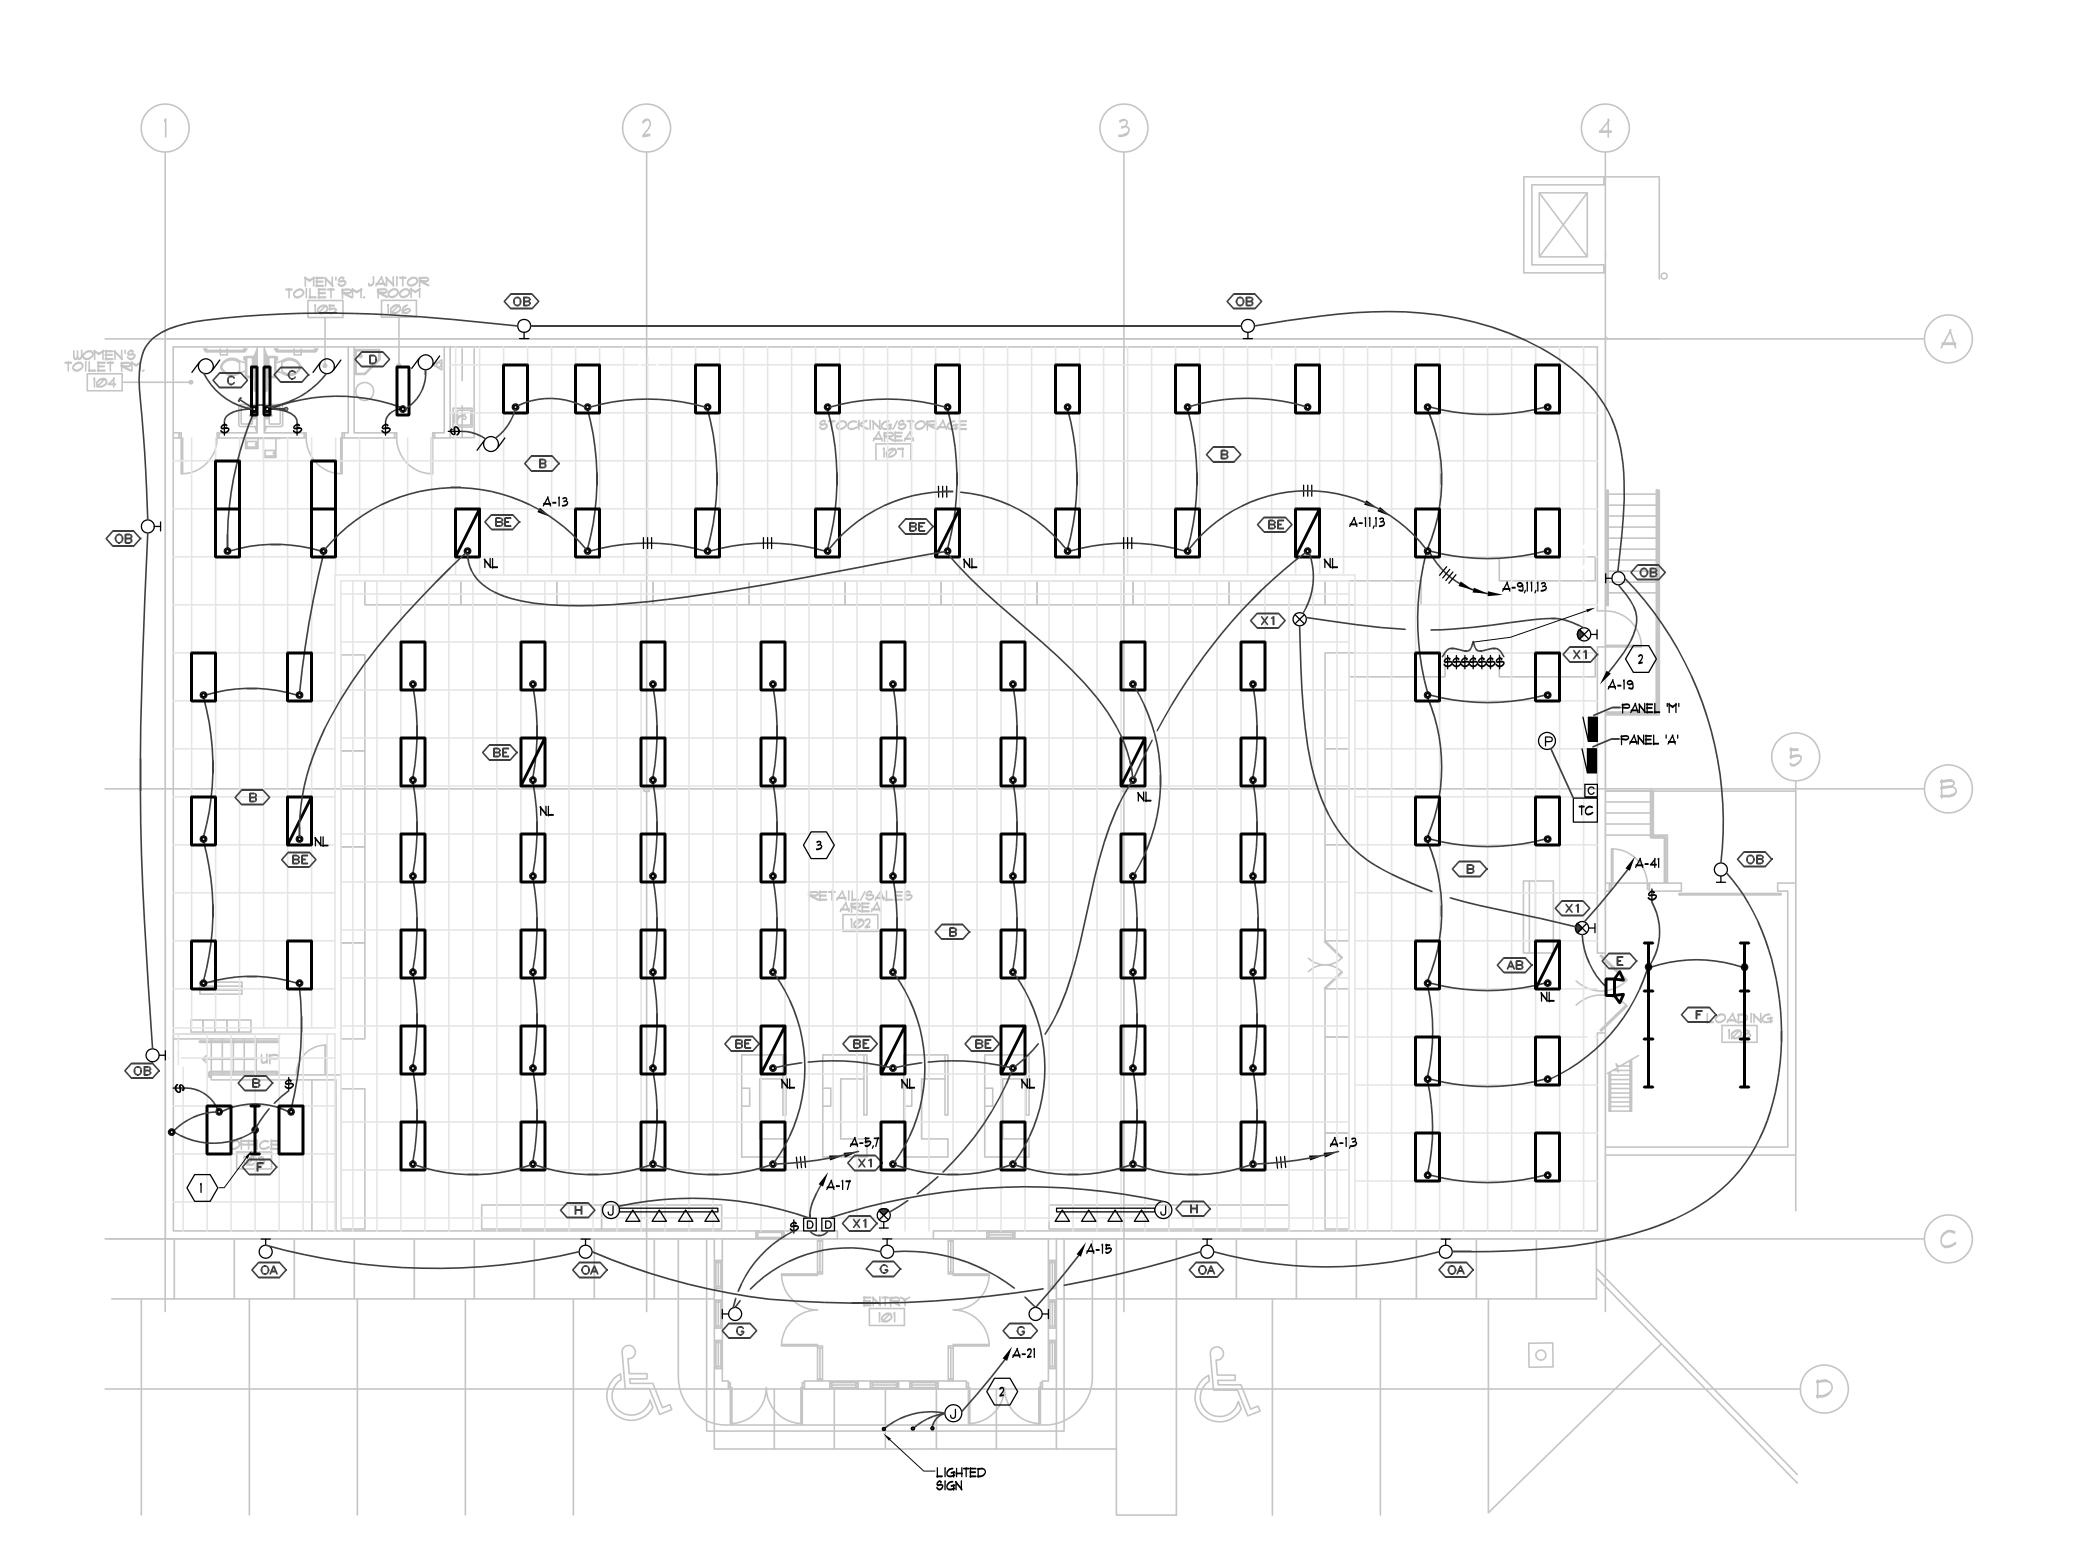






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24

STORE

OGDEN PATTERSON LIQUOR

OGDEN - UTAH

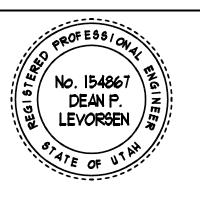OWNER

DEPARTMENT OF ALCOHOLIC BEVERAGE CONTROL


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	10-18-05	DESIGN DEVELOPMENT
MARK	DATE	DESCRIPTION

PROJECT NUMBER:
DRAWING FILE:
DRAWN BY:
CHECKED BY:

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SHEET TITLE

Lighting Floor Plan

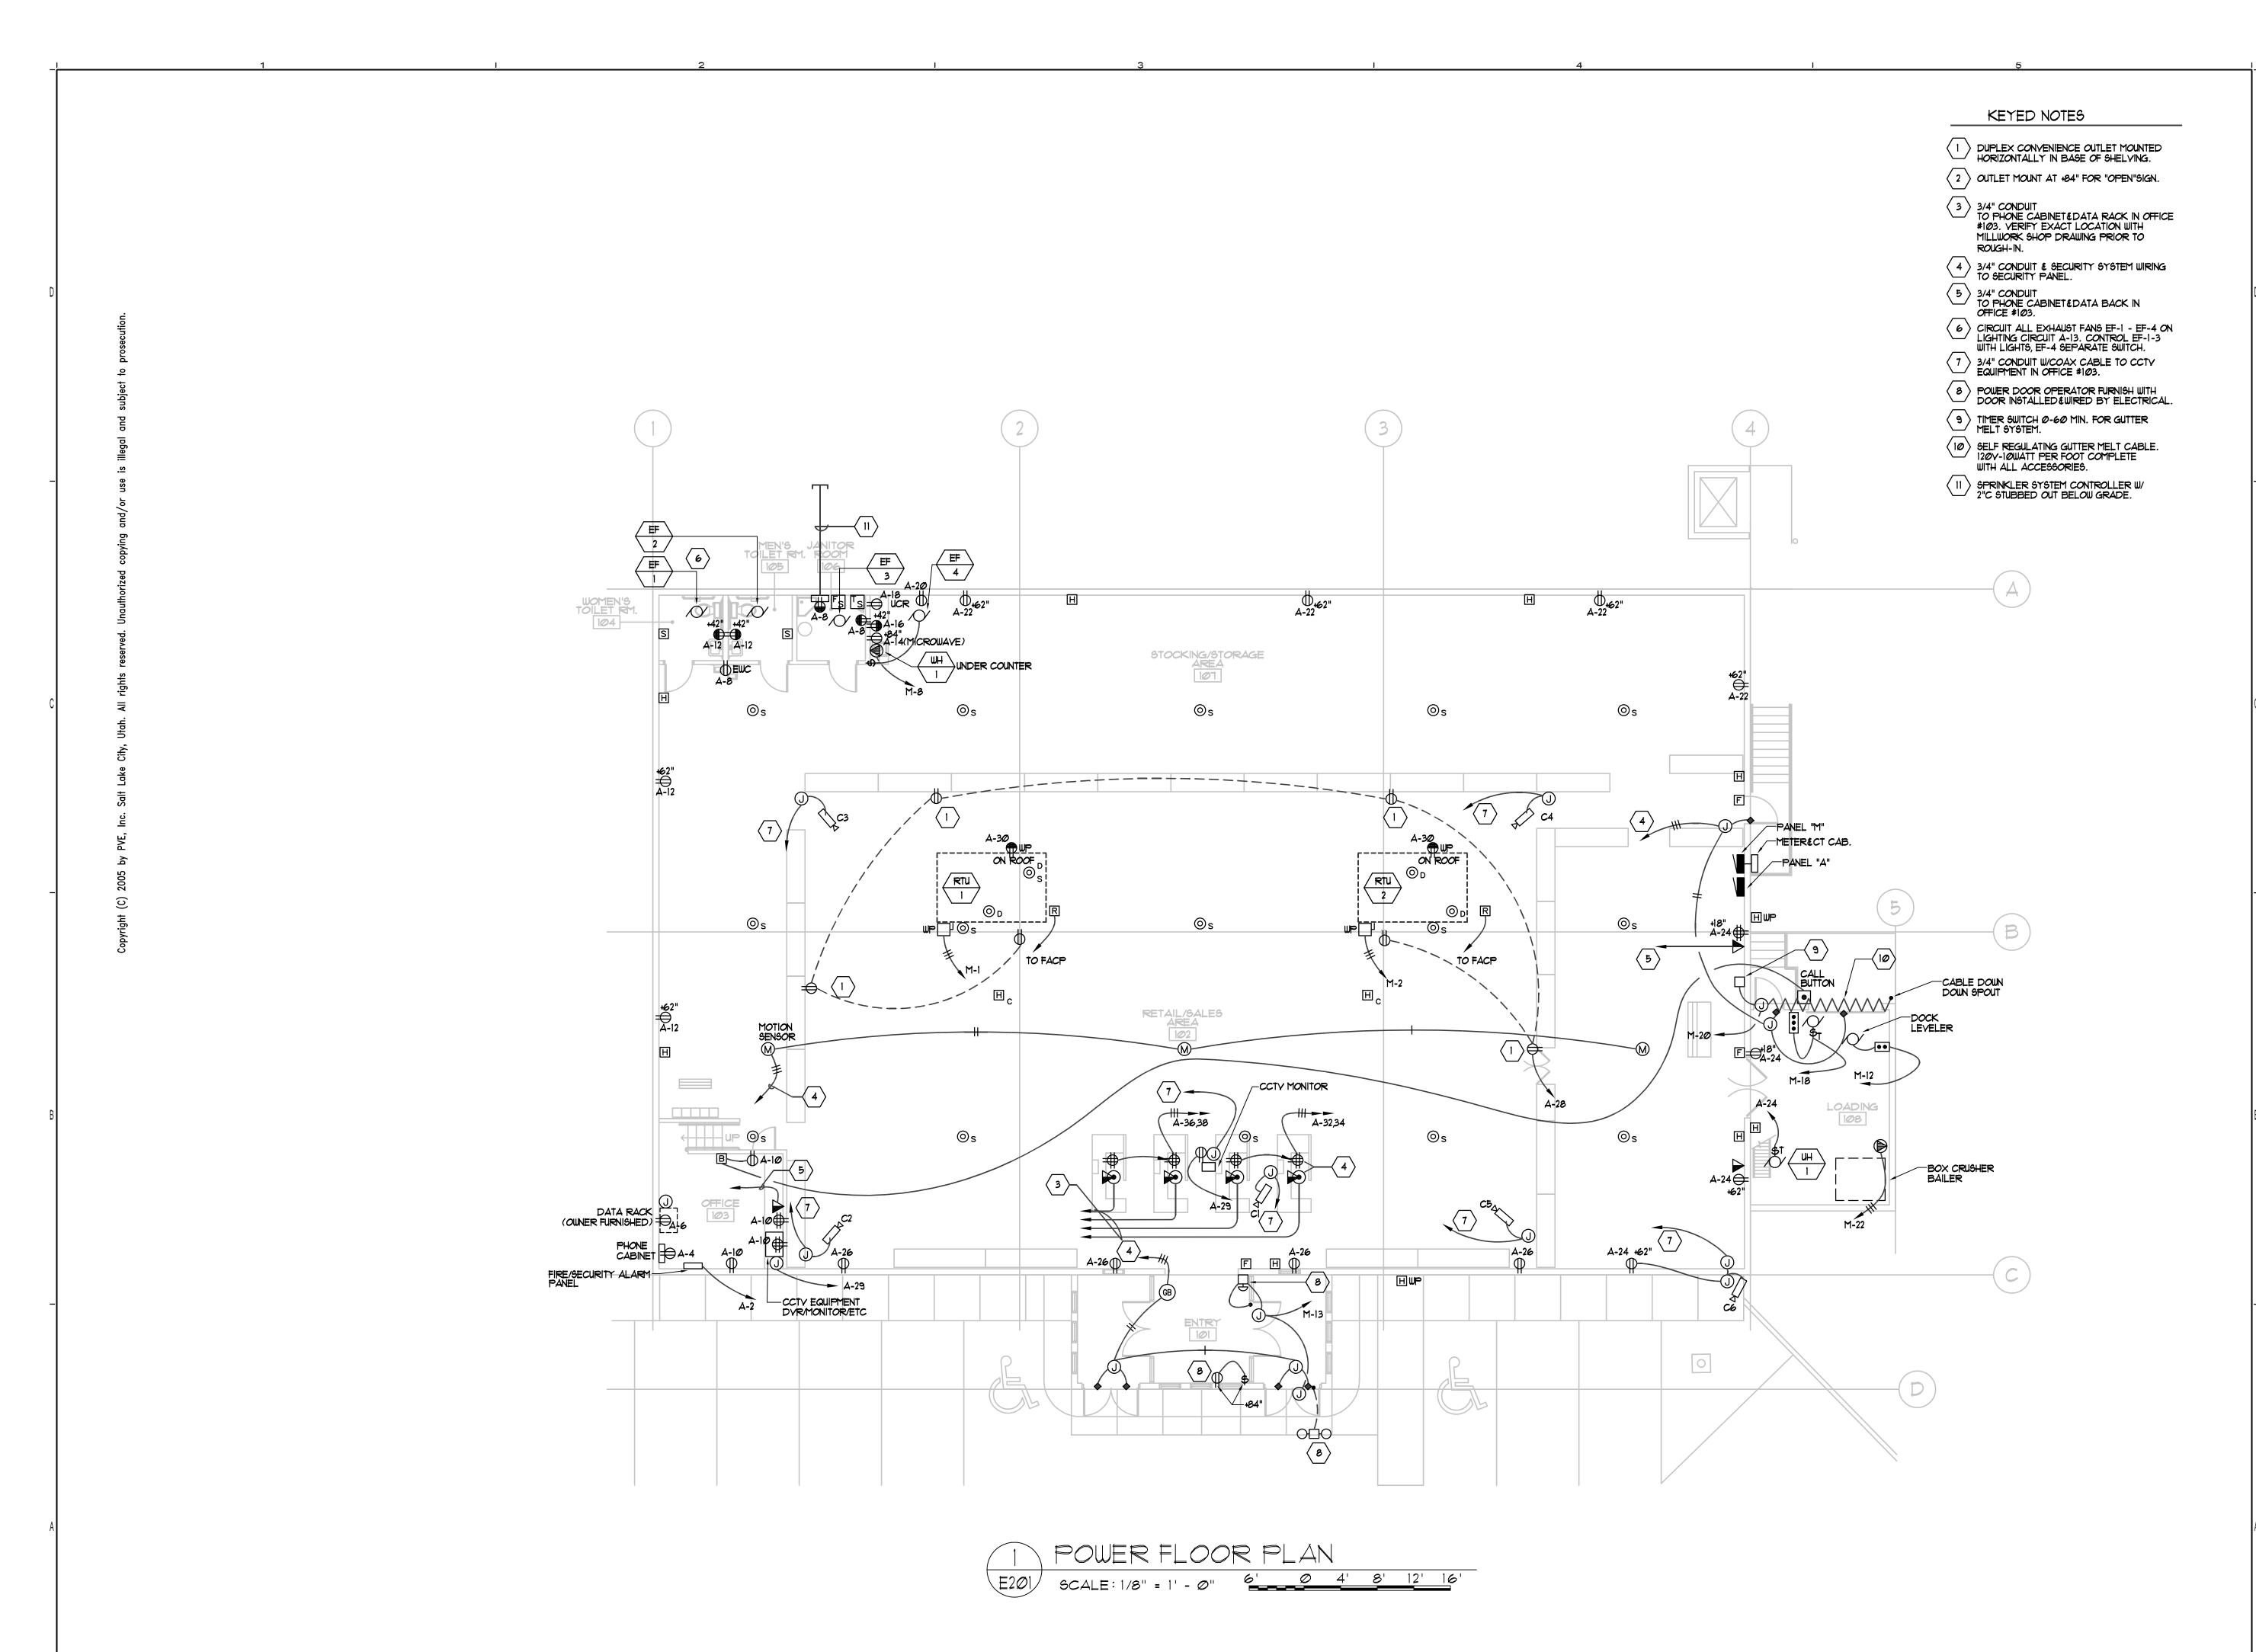


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OGDEN PAT

OWNER DEPARTMENT (


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	10-18-05	DESIGN DEVELOPMENT
MARK	DATE	DESCRIPTION

PROJECT NUMBER: 05156.01 DRAWING FILE: See Drawing Stamp DRAWN BY: CHECKED BY:

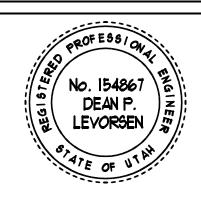
RKR

SHEET TITLE


Power Floor Plan

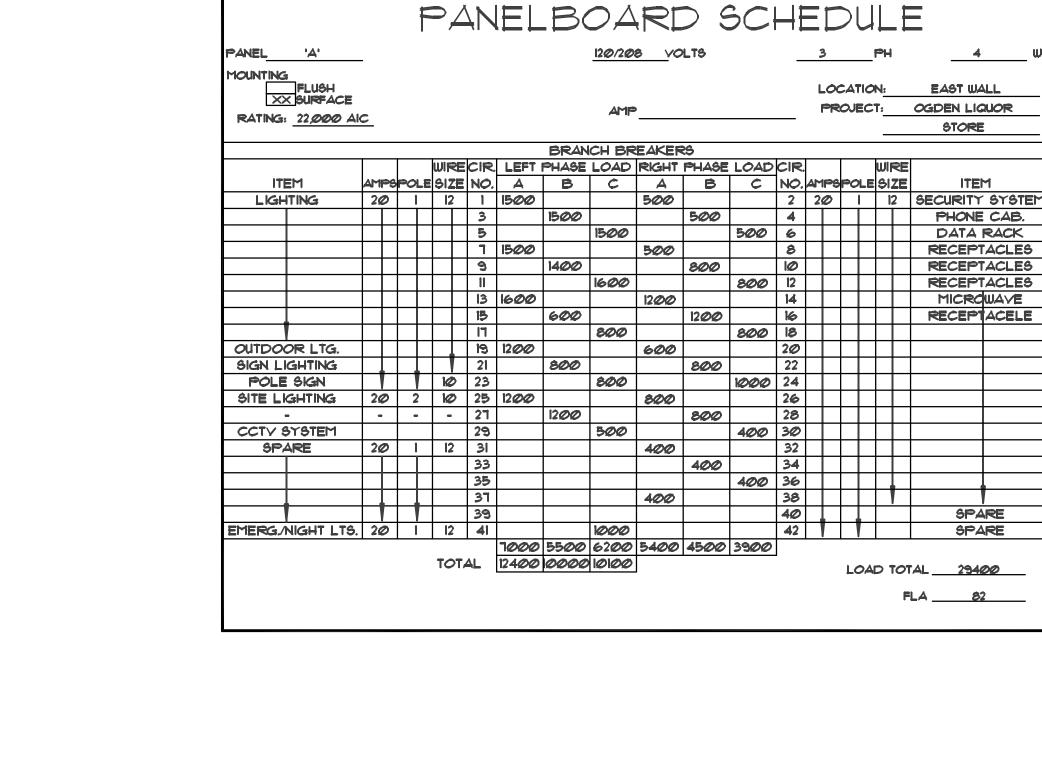


SCHEMATIC

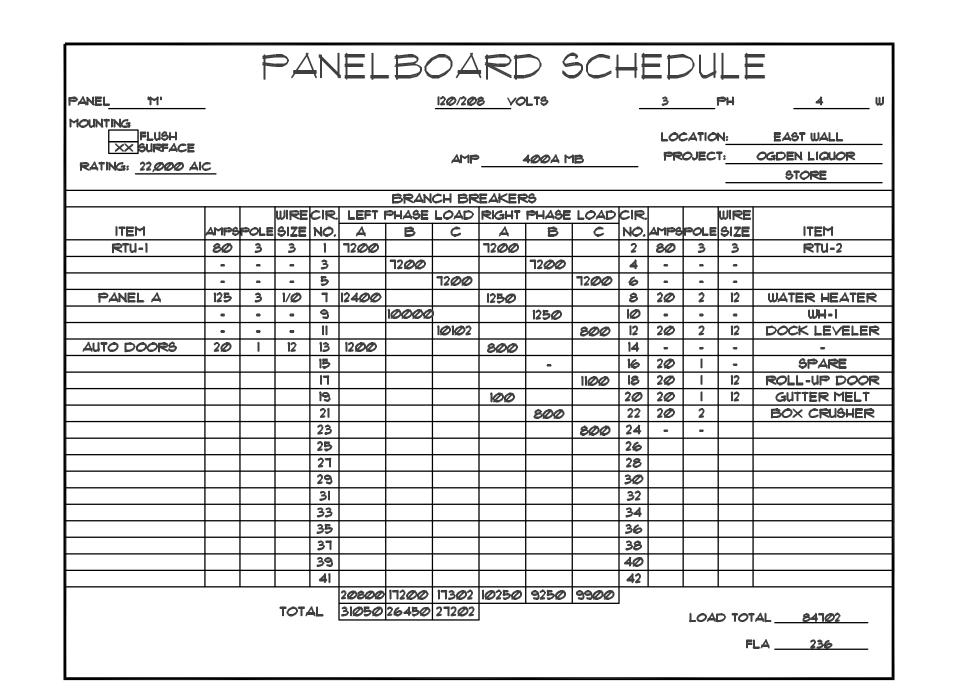

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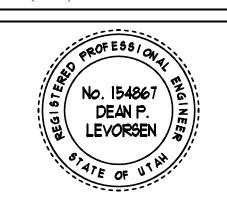
SECURITY SYSTEM WIRING DIAGRAM
SCHEMATIC

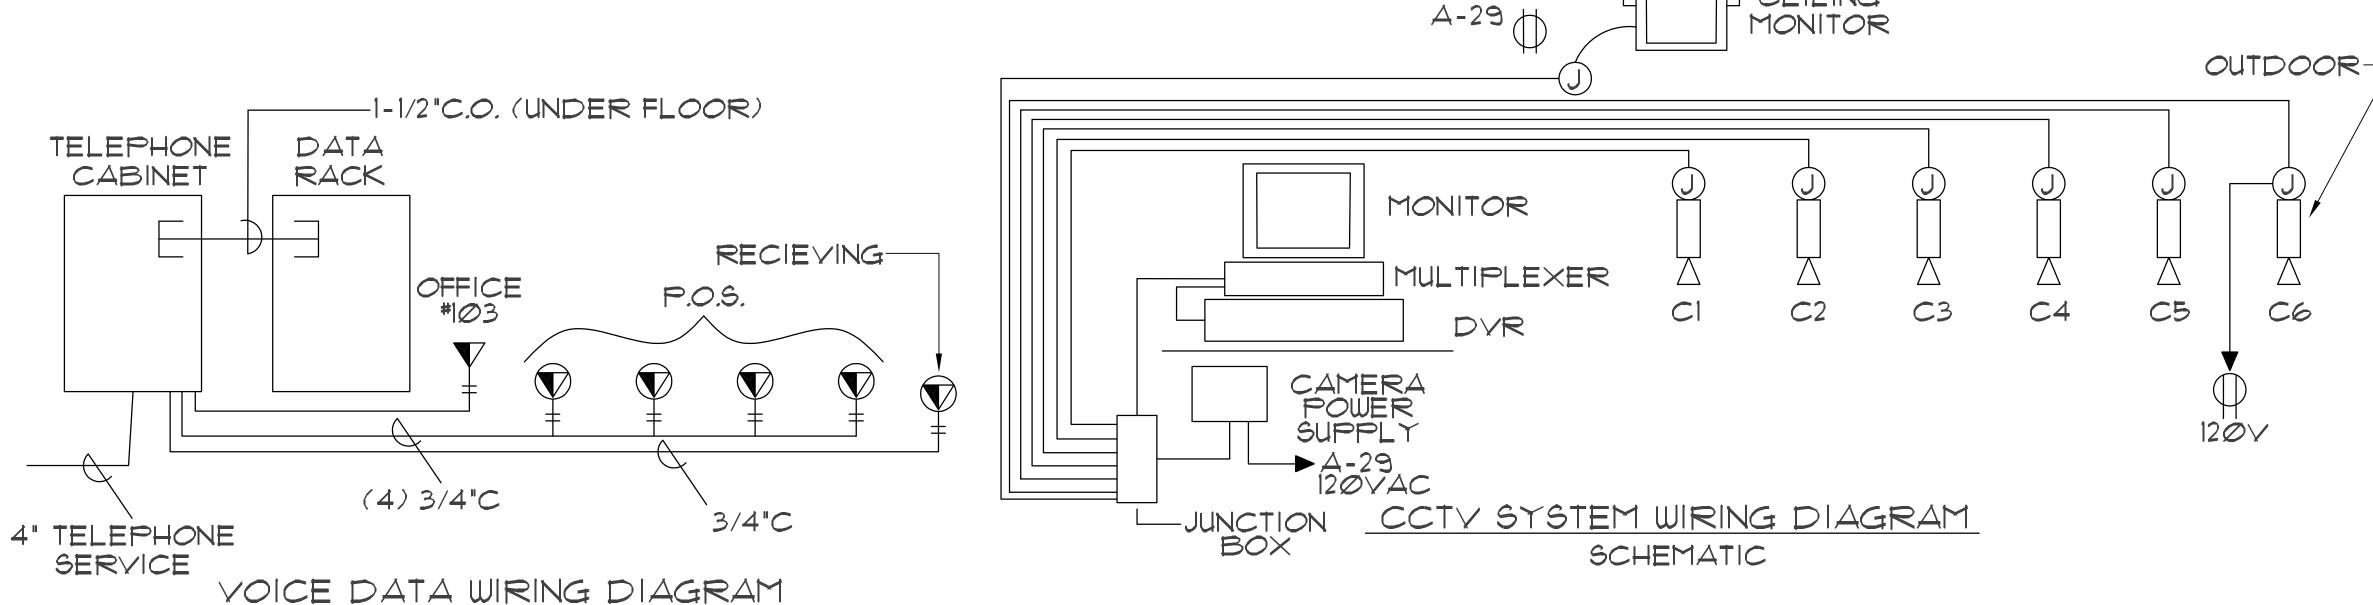
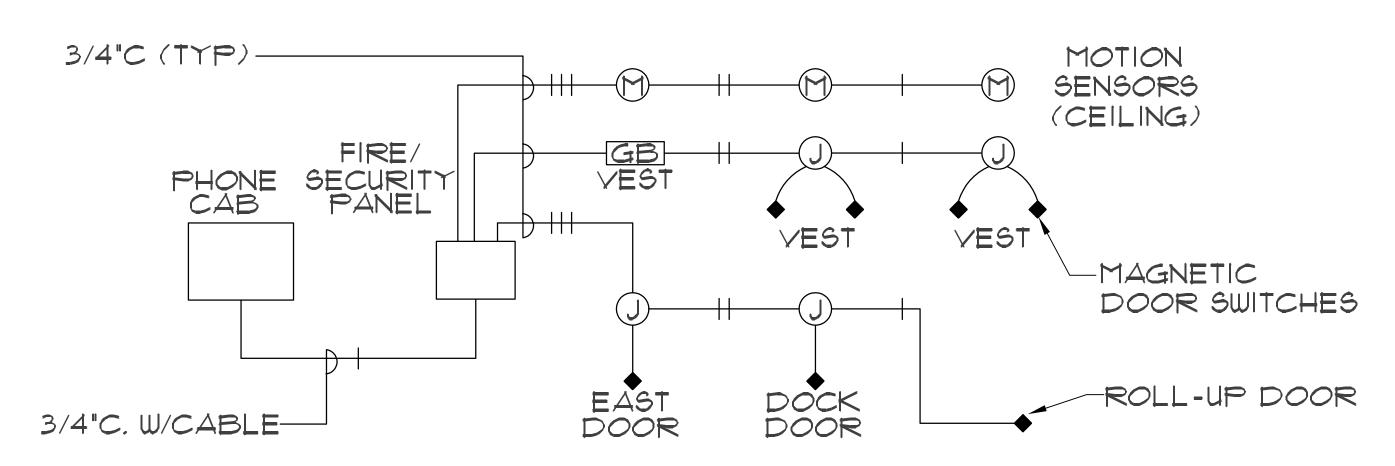
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OGDEN - UTAH

OMNER

DEPARTMENT OF ALCOHOLIC BEVERAGE CONTROL

		12-16-05	REVIEW COMMENTS
-		10-18-05	DESIGN DEVELOPMENT
	MARK	DATE	DESCRIPTION

PROJECT NUMBER: 05156.01

DRAWING FILE: See Drawing Stamp

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SCHEDULES & SCHEMATICS